

PLANNING NOTICE

An application has been received for a Permit under s.57 of the Land Use Planning Approvals Act 1993:

APPLICANT:	Wilson Homes - PA\24\0238
PROPERTY ADDRESS:	32 Liddesdale Drive DELORAINE
	(CT: 185043/19)
DEVELOPMENT:	Single dwelling - road attenuation.

The application can be inspected until **Monday, 15 July 2024**, at <u>www.meander.tas.gov.au</u> or at the Council Office, 26 Lyall Street, Westbury (during normal office hours).

Written representations may be made during this time addressed to the General Manager, PO Box 102, Westbury 7303, or by email to <u>planning@mvc.tas.gov.au</u>. Please include a contact phone number. Please note any representations lodged will be available for public viewing.

If you have any questions about this application please do not hesitate to contact Council's Planning Department on 6393 5320.

Dated at Westbury on 29 June 2024.

Jonathan Harmey GENERAL MANAGER

APPLICATION FORM



PLANNING PERMIT

Land Use Planning and Approvals Act 1993

- Application form & details MUST be completed IN FULL.
- Incomplete forms will not be accepted and may delay processing and issue of any Permits.

					OFFICE USE ONLY					
Property No:		Assessment No:		-						
DA\	P	ΡΑ\		PC\						
 Is your application the result of an illegal building work? Have you already received a Planning Review for this proposal? Is a new vehicle access or crossover required? Yes Yes No Indicate by ✓ box 										
PROPERTY DETAILS:										
Address:	(Lot 19) 32 Lid	Idesdale Drive		Certificate of Title:	185043					
Suburb:	Deloraine	730	4	Lot No:	19					
Land area:	1636.01			m² / ha						
Present use of land/building:	Vacan Land			(vacant, commercia	residential, rural, industrial, al or forestry)					
 Does the application involve Crown Land or Private access via a Crown Access Licence: Yes Yes No Heritage Listed Property: Yes Y No 										
DETAILS OF US	E OR DEVELO	PMENT:								
Indicate by ✓ box	Building worForestry	rk Change of use Other		Subdivision	Demolition					
Total cost of development (inclusive of GST): Includes total cost of building work, landscaping, road works and infrastructure										
Description of work: New Dwelling										
Use of building:										
New floor area:	144.49	m ² New building heig	9ht: 4,9	965 m						
Materials:	External walls:	Brick veneer		Colour: TBC						
	Roof cladding:	Sheet metal		Colour: TBC						





SEARCH OF TORRENS TITLE

VOLUME	FOLIO
185043	19
EDITION	DATE OF ISSUE
2	06-Sep-2023

SEARCH DATE : 01-Oct-2023 SEARCH TIME : 12.56 PM

DESCRIPTION OF LAND

Parish of MALLING Land District of DEVON Lot 19 on Sealed Plan 185043 Derivation : Part of Lot 429, 213 Acres Gtd. to J. Duff Mackay & William Kenney Prior CTs 46419/1 and 46420/2

SCHEDULE 1


N151069 TRANSFER to VICTORIA LOUISE VAN LOON and STEPHEN MICHAEL VAN LOON Registered 06-Sep-2023 at noon

SCHEDULE 2

Reservations and conditions in the Crown Grant if any SP185043 EASEMENTS in Schedule of Easements SP185043 FENCING COVENANT in Schedule of Easements SP185043 SEWERAGE AND/OR DRAINAGE RESTRICTION B738897 PROCLAMATION under Section 52A of the Roads and Jetties Act 1935 Registered 10-May-1995 at noon

UNREGISTERED DEALINGS AND NOTATIONS

No unregistered dealings or other notations

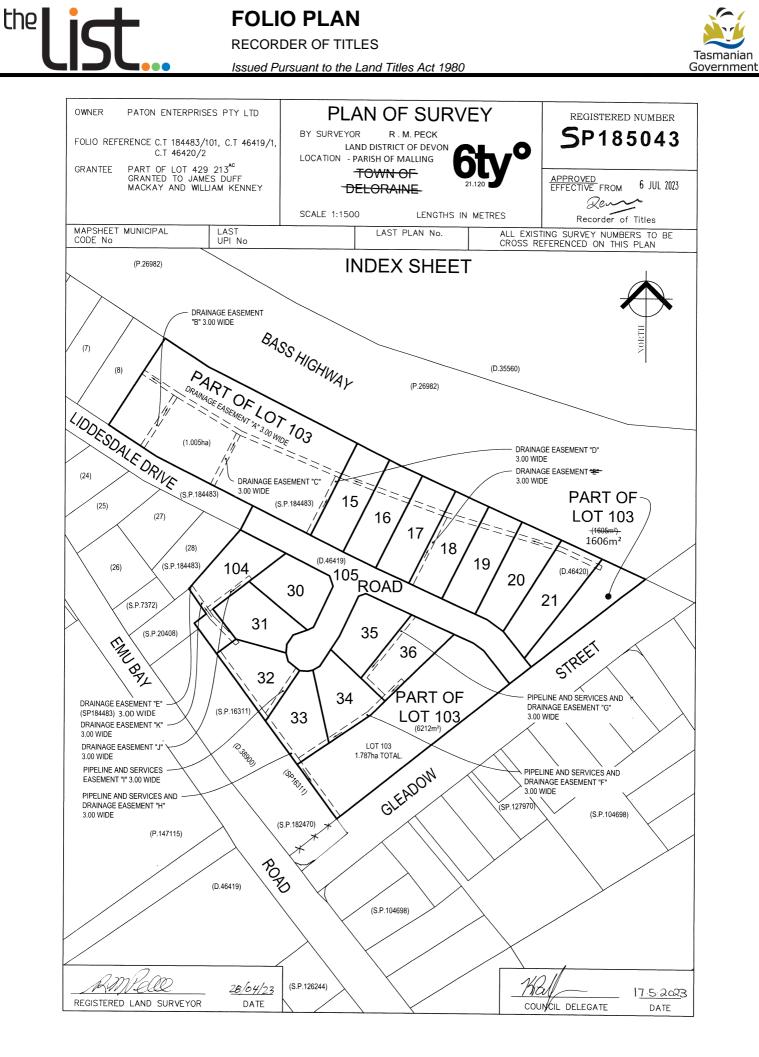




FOLIO PLAN

RECORDER OF TITLES

Issued Pursuant to the Land Titles Act 1980



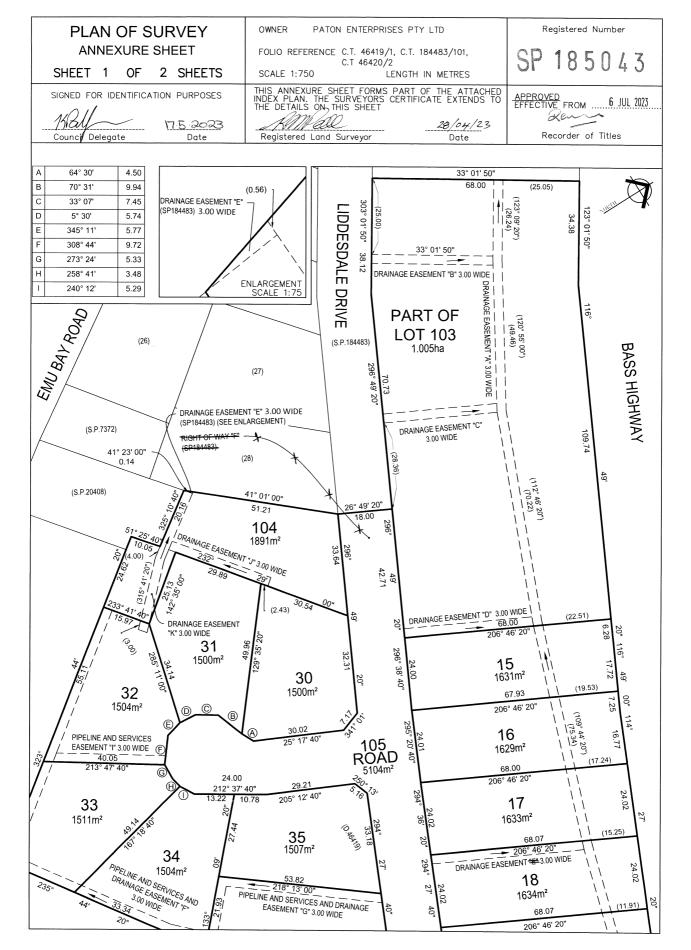




FOLIO PLAN

RECORDER OF TITLES

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SCHEDULE OF EASEMENTS

RECORDER OF TITLES
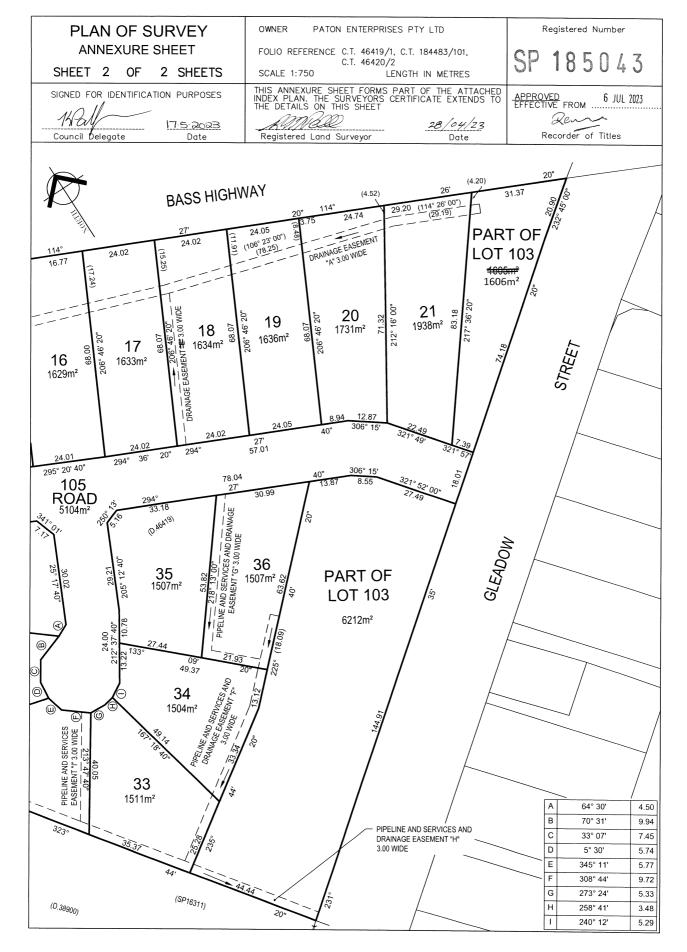
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SCHEDULE OF EASEMENTS

NOTE: THE SCHEDULE MUST BE SIGNED BY THE OWNERS & MORTGAGEES OF THE LAND AFFECTED. SIGNATURES MUST BE ATTESTED.



Registered Number

85

EASEMENTS AND PROFITS

Each lot on the plan is together with:-

such rights of drainage over the drainage easements shown on the plan (if any) as may be necessary to drain (1)the stormwater and other surplus water from such lot; and

(2)any easements or profits a prendre described hereunder.

Each lot on the plan is subject to:-

(1) such rights of drainage over the drainage easements shown on the plan (if any) as passing through such lot as may be necessary to drain the stormwater and other surplus water from any other lot on the plan; and

(2) any easements or profits a prendre described hereunder.

The direction of the flow of water through the drainage easements shown on the plan is indicated by arrows.

Lots 15 to 21 (inclusive) and Lot 103 on the Plan are each SUBJECT TO a right of drainage for the Meander Valley Council over the land marked Drainage Easement "A" 3.00 Wide shown on the Plan.

Lot 103 on the Plan is SUBJECT TO a right of drainage for the Meander Valley Council over the land marked Drainage Easement "B" 3.00 Wide shown on the Plan.

Lot 103 on the Plan is SUBJECT TO a right of drainage for the Meander Valley Council over the land marked Drainage Easement "C" 3.00 Wide shown on the Plan.

Lot 103 on the Plan is SUBJECT TO a right of drainage for the Meander Valley Council over the land marked Drainage Easement "D" 3.00 Wide shown on the Plan.

Lot 18 on the Plan is <u>SUBJECT TO</u> a right of drainage for the Meander Valley Council over the land marked Drainage Easement "X" 3.00 Wide shown on the Plan.

Lots 33, 34 and 36 on the Plan are each SUBJECT TO a right of drainage for the Meander Valley Council over the land marked Pipeline and Services and Drainage Easement "F" 3.00 Wide shown on the Plan.

Lot 36 on the Plan is SUBJECT TO a right of drainage for the Meander Valley Council over the land marked Pipeline and Services and Drainage Easement "G" 3.00 Wide shown on the Plan.

Lots 32, 33 and 103 on the Plan are each SUBJECT TO a right of drainage for the Meander Valley Council over the land marked Pipeline and Services and Drainage Easement "H" 3.00 Wide shown on the Plan.

(USE ANNEXURE PAGES FOR CONTINUATION)

SUBDIVIDER: PATON ENTERPRISES PTY LTD	PLAN SEALED BY: Meander	Valley Council				
FOLIO REF: 46419/1, 184483/101 and 46420/2	DATE: 17 May 2023					
SOLICITOR & REFERENCE: Shields Heritage DA Smith	PA 23 0020 REF NO.	Council Delegate				
NOTE: The Council Delegate must sign the Certificate for the purposes of identification.						

Volume Number: 185043



RECORDER OF TITLES

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ANNEXURE TO SCHEDULE OF EASEMENTS

PAGE 2 OF 4 PAGES

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SUBDIVIDER: PATON ENTERPRISES PTY LTD FOLIO REFERENCE: 46419/1, 184483/101 and 46420/2

Lot 104 on the Plan is SUBJECT TO a right of drainage for the Meander Valley Council over the land marked Drainage Easement "J" 3.00 Wide shown on the Plan.

Lots 32 and 104 on the Plan are each SUBJECT TO a right of drainage for the Meander Valley Council over the land marked Drainage Easement "K" 3.00 Wide shown on the Plan.

Lot 104 on the Plan is SUBJECT TO a right of drainage for the Meander Valley Council over the land marked Drainage Easement "E" (SP184483) shown on the Plan. $v_{3.00}$ wide

Lots 33, 34 and 36 on the Plan are each SUBJECT TO a Pipeline and Services Easement (as defined herein) in gross in favour of TasWater over the land marked Pipeline and Services and Drainage Easement "F" 3.00 Wide shown on the Plan ("the Easement Land").

Lot 36 on the Plan is SUBJECT TO a Pipeline and Services Easement (as defined herein) in gross in favour of TasWater over the land marked Pipeline and Services and Drainage Easement "G" 3.00 Wide shown on the Plan ("the Easement Land").

Lots 32, 33 and 103 on the Plan are each SUBJECT TO a Pipeline and Services Easement (as defined herein) in gross in favour of TasWater over the land marked Pipeline and Services and Drainage Easement "H" 3.00 Wide shown on the Plan ("the Easement Land").

Lot 32 on the Plan is SUBJECT TO a Pipeline and Services Easement (as defined herein) in gross in favour of TasWater over the land marked Pipeline and Services Easement "I" 3.00 Wide shown on the Plan ("the Easement Land").

"Pipeline and Services Easement" is defined as follows:-

FIRSTLY, THE FULL AND FREE RIGHT AND LIBERTY for TasWater and its employees, contractors, agents and all other persons duly authorised by it, at all times to:-

- enter and remain upon the Easement Land with or without machinery, vehicles, plant and equipment; (1)
- (2)investigate, take soil, rock and other samples, survey, open and break up and excavate the Easement Land for any purpose or activity that TasWater is authorised to do or undertake;
- (3)install, retain, operate, modify, relocate, maintain, inspect, cleanse, repair, remove and replace the Infrastructure:

NOTE: Every annexed page must be signed by the parties to the dealing or where the party is a corporate body be signed by the persons who have attested the affixing of the seal of that body to the dealing.



SCHEDULE OF EASEMENTS

RECORDER OF TITLES

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ANNEXURE TO SCHEDULE OF EASEMENTS PAGE 3 OF 4 PAGES

Registered Number

SUBDIVIDER: PATON ENTERPRISES PTY LTD FOLIO REFERENCE: 46419/1, 184483/101 and 46420/2

- (4)run and pass sewage, water and electricity through and along the Infrastructure;
- (5)do all works reasonably required in connection with such activities or as may be authorised or required by any law:
 - (1) without doing unnecessary damage to the Easement Land; and
 - (2) leaving the Easement Land in a clean and tidy condition;
- (6)if the Easement Land is not directly accessible from a highway, then for the purpose of undertaking any of the preceding activities TasWater may with or without employees, contractors, agents and any other persons authorised by it, and with or without machinery, vehicles, plant and equipment enter the relevant Lot from the highway at any vehicle entry and cross the relevant Lot to the Easement Land; and
- (7)use the Easement Land as a right of carriageway for the purpose of undertaking any of the preceding purposes on other land, TasWater reinstating any damage that it causes in doing so to any boundary fence of the relevant Lot.

SECONDLY, the benefit of a covenant in gross for TasWater with the registered proprietor/s of the Easement Land and their successors and assigns not to erect any building, or place any structures, objects, vegetation, or remove any thing that supports, protects or covers any Infrastructure on or in the Easement Land, without the prior written consent of TasWater to the intent that the burden of the covenant may run with and bind the servient land and every part thereof and that the benefit thereof maybe annexed to the easement herein described.

Interpretation:

"Infrastructure" means infrastructure owned or for which TasWater is responsible and includes but is not limited to:

- (a) sewer pipes and water pipes and associated valves;
- (b) telemetry and monitoring devices;
- (c) inspection and access pits;
- (d) electricity assets and other conducting media (excluding telemetry and monitoring devices);

NOTE: Every annexed page must be signed by the parties to the dealing or where the party is a corporate body be signed by the persons who have attested the affixing of the seal of that body to the dealing.



SCHEDULE OF EASEMENTS

RECORDER OF TITLES

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ANNEXURE TO SCHEDULE OF EASEMENTS

PAGE 4 OF 4 PAGES

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Registered Number

SUBDIVIDER: PATON ENTERPRISES PTY LTD FOLIO REFERENCE: 46419/1, 184483/101 and 46420/2

- (e) markers or signs indicating the location of the Easement Land or any other Infrastructure or any warnings or restrictions with respect to the Easement Land or any other Infrastructure;
- (f) anything reasonably required to support, protect or cover any other Infrastructure;
- (g) any other Infrastructure whether of a similar nature or not to the preceding which is reasonably required for the piping of sewage or water, or the running of electricity, through the Easement Land or monitoring or managing that activity; and
- (h) where the context permits, any part of the Infrastructure.

"TasWater" means Tasmanian Water & Sewerage Corporation Pty Ltd (ACN 162 220 653), its successors and assigns.

FENCING COVENANT

sole company secretary

The owner of each Lot covenants with the Vendor Paton Enterprises Pty Ltd (A.C.N. 639 417 217) that the said Paton Enterprises Pty Ltd (A.C.N. 639 417 217) shall not be required to fence.

EXECUTED by PATON ENTERPRISES PTY LTD (A.C.N. 639 417 217)) the registered proprietor of the land comprised in Folios of the Register Volume 46419 Folio) 1, Volume 184483 Folio 101 and Volume) 46420 Folio 2 pursuant to Section 127(1)(c) of the Corporations Act 2001 by being signed)

by the company's sole director who is also the)

Jason John/Sherriff

NOTE: Every annexed page must be signed by the parties to the dealing or where the party is a corporate body be signed by the persons who have attested the affixing of the seal of that body to the dealing.

Revision Number: 02

DA		AS & NCC COMPLIAN	CE	3D PERSPECTIVE	
		ALL CONSTRUCTION TO BE IN ACCO APPLICABLE AUSTRALIAN STANDA			
A SLAB IN ACCORDANCE WITH AS 2870. REFER TO ENGINEERS DETAILS BRICK CONTROL JOINTS PROVIDED IN ACCORDANCE WITH NCC 2022.					
				GROUND FLOOR TOP OF WALL HEIGHT(S) 2445mm NOTE: CEILING HEIGHT 45mm LOWER THAN TOP OF W	
SHEET INDEX - ALL STEEL FRAMING TO BE DESIGNED TO AS 4100-2020 OR AS/NZS			GNED TO AS 4100-2020 OR AS/NZS		ROOF PITCH (U.N.O.) 23.0°
1 COVER SHEET 2 SITE PLAN			ACCORDANCE WITH NCC 2022 AND		ELECTRICITY SUPPLY SINGLE PH GAS SUPPLY NONE
3 SOIL & WATER MANAGEMENT PLAN		- TERMITE PROTECTION IN ACCOR	RDANCE WITH AS 3660 AND NCC 2022.		ROOF MATERIAL SHEET ME
4 GROUND FLOOR PLAN 5 ELEVATIONS / SECTION		 GLAZING IN ACCORDANCE WITH SMOKE ALARMS IN ACCORDANC 			ROOF COLOUR N/A WALL MATERIAL BRICK VEN
6 ELEVATIONS		 INTERNAL WATERPROOFING IN A HOUSING PROVISIONS PART 10.2 			SLAB CLASSIFICATION TBC
7 WINDOW & DOOR SCHEDULES 8 ROOF DRAINAGE PLAN		- EXTERNAL WATERPROOFING IN	ACCORDANCE WITH AS 3740 AND AS		INSULATION
9 FLOOR COVERINGS			FLOOR WASTES AT MIN. 1:80 AND MAX.		ROOF SARKING UNDER ROOFING
10 KITCHEN DETAILS		1:50 GRADE (IF APPLICABLE). - CONDENSATION MANAGEMENT I	N ACCORDANCE WITH NCC 2019.		CEILING R4.1 BATTS (EXCL. GARAGE, ALFRESC
11 BATHROOM DETAILS 12 LAUNDRY DETAILS		 BUILDING SEALING IN ACCORDAT SERVICES IN ACCORDANCE WITH 			R2.0 BATTS SOUNDSCREEN LAYER AS EXT. WALLS R2.0 BATTS (EXCL. GARAGE)
		- EARTHWORKS IN ACCORDANCE	WITH AS 3798-2007.		WALL WRAP TO ENTIRE HOUSE
		APPLICABLE).	G) IN ACCORDANCE WITH NCC 2022 (IF		INT. WALLS R2.0 BATTS ADJACENT TO GARAGE AN FLOOR BIAX SLAB
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GARAGE	20.93	CONTROL	DETAILS		
LIVING	109.68	ACID SULPHATE SOIL	NO		
PORCH	2.39 144.49 m ²	BIODIVERSITY BUILDING ENVELOPE	NO YES	NOTE TO OWNER	
		BUSHFIRE	BAL-LOW	THESE PLANS MAY FEATURE WORKS THAT ARE EXCLUDED FROM THE SCOPE OF WORKS WITH THE BUILDER, BUT THEY HAVE BEEN INCLUDED IN	
		CLIMATE ZONE (NCC)	ZONE 7 - COOL TEMPERATE	THESE DRAWINGS TO ASSIST IN THE OVERALL PLANNING AND ASSESSMENT OF THE BUILDING PROJECT. EXAMPLES OF SOME REGULARLY EXCLUDED WORKS INCLUDE DRIVEWAYS, RETAINING WALLS, SOLAR PANEL SPACING AND SITE DRAINAGE. PLEASE REFER TO YOUR SCOPE OF	
TRAFFIC NOISE ASSESSM	ENT.	DESIGN WIND CLASSIFICATION ESTATE/DEVELOPER GUIDELINES	N3 (NOT EXPOSED) NO	WORKS AND COLOUR SELECTIONS DOCUMENTATION FOR DETAILS OF INCLUDED WORKS. SOME DETAILS ARE INDICATIVE ONLY FOR EXAMPLE FLOORING, TILING, BRICKWORK AND CLADDING (EXPANSION JOINTS, ORIENTATION AND LAYOUT) AND ARE SUBJECT TO CHANGE.	
REFER TO RECOMMENDAT	IONS	FLOOD OVERLAY	NO		
AS PER REPORT PREPARE	DBY	HERITAGE LANDSLIP HAZARD	NO NO		
TARKARRI ENGINEERIN		MINIMUM FLOOR LEVEL	NO		
(16.04.2024)		NATURAL ASSET CODE NOISE ATTENUATION	NO NO		
(10.04.2024)		SALINE SOIL	NO		
		SHIELDING FACTOR	PS - PARTIAL SHIELDING		
		SITE CLASSIFICATION SPECIFIC AREA PLAN OVERLAY	MNO		
		TERRAIN CATEGORY	TC2.5		oved int
		TOPOGRAPHIC CLASSIFICATION WATERWAY & COASTAL OVERLAY	T2 NO		ats: a approprion point
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		LANDSCAPE NO APPLICABLE CONTROLS		This Plan rossolve Investig	SIGNATURE:
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		FILL DEPTH	MAX. 1,000mm 214mm	Cettilicon plan Gev	
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		ACCESS & AMENITY PARKING SPACES	MIN. 2 SPACES 2 SPACES	Magnete , ##5 *** Magnete , ##5 ** Magnete , ##5 ** Magnete , ##5 ** ** ** ** ** ** **	

PRELIMINARY PLAN SET

No.	AMENDMENT	SHEET	DATE	DRAWN	CHECK
4	PRELIMINARY PLAN SET - INITIAL ISSUE	ALL	2024.02.19	MT/HMI	DKZ
5	PRELIMINARY PLAN SET - VARIATION REF. 001 UPDATE	ALL	2024.04.10	MLG	-
6	PRELIMINARY PLAN SET - RFI & VARIATION REF. 002 UPDATE	1, 4	2024.06.07	MLG	-

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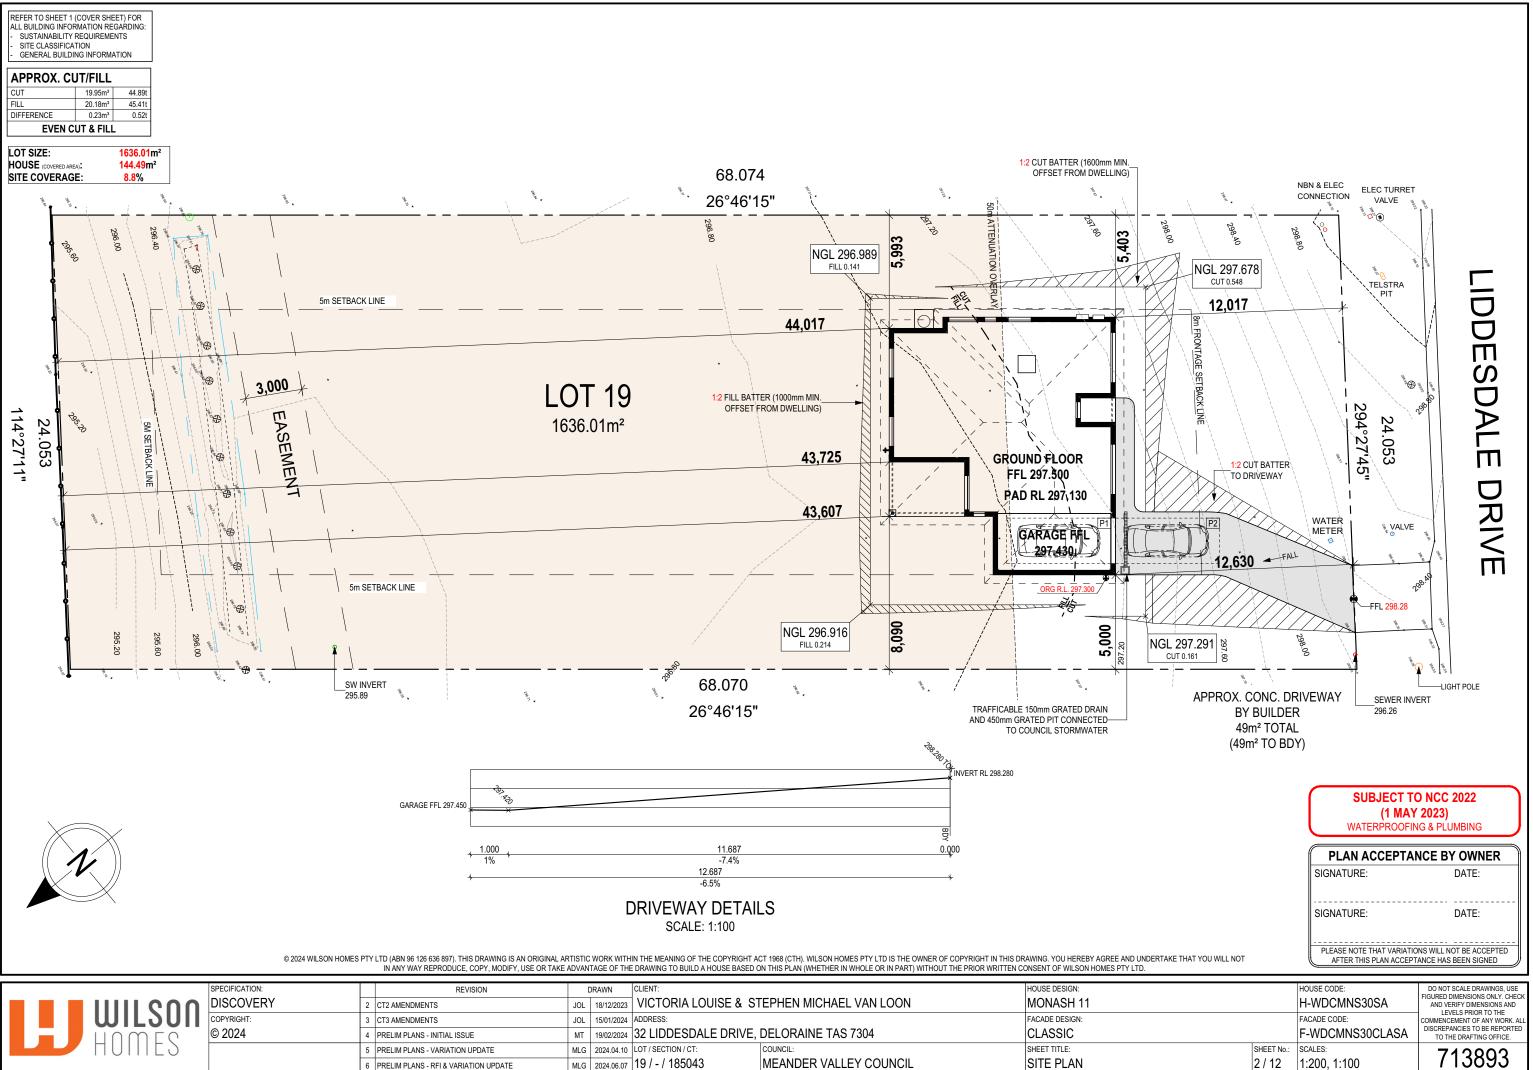
		SPECIFICATION:	REVISION	C	DRAWN CLIENT:		HOUSE DESIGN:
		DISCOVERY	2 CT2 AMENDMENTS	JOL	18/12/2023 VICTORIA LOUISE & ST	MONASH 11	
		COPYRIGHT: © 2024	3 CT3 AMENDMENTS	JOL	15/01/2024 ADDRESS:	FACADE DESIGN:	
			4 PRELIM PLANS - INITIAL ISSUE	MT	19/02/2024 32 LIDDESDALE DRIVE, I	CLASSIC	
	HUIIIES		5 PRELIM PLANS - VARIATION UPDATE	MLG			SHEET TITLE:
			6 PRELIM PLANS - RFI & VARIATION UPDATE	MLG	2024.06.07 19 / - / 185043	MEANDER VALLEY COUNCIL	COVER SHEET

2445mm
NTOP OF WALL
23.0°
SINGLE PHASE
NONE
SHEET METAL
N/A
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TBC
, ALFRESCO & PATIO) PLUS
LAYER AS PER ENG. REPORT
i)
USE
GARAGE AND AS PER PLAN


DWLEDGE THAT THESE CONTRACT PLANS MAY NOT REFLECT ALL THE AVE BEEN MADE OR CHANGES REQUESTED. THE OWNERS AGREE THAT LOUR SELECTIONS VARIATION OR UPDATING OF PLANS, THEY WILL BE PROVIDED N PLANS FOR SIGNATURE PRIOR TO COMMENCEMENT OF CONSTRUCTION.


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		SIGNATURE:	DATE:	a: D:\8 Draffina\ lch Eilee\713800\713803
AKE THAT YOU WILL NOT		PLEASE NOTE THAT VARIATIO		
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		FACADE CODE: F-WDCMNS30CLASA	LEVELS PRIOR TO THE COMMENCEMENT OF ANY WORK. ALL DISCREPANCIES TO BE REPORTED TO THE DRAFTING OFFICE.	Voreion: 24
-	SHEET No.: 1 / 12	scales: 1:100	713893	Complete



	SPECIFICATION:		REVISION	I	DRAWN CLIENT:	HOUSE DESIGN:
	DISCOVERY	2 (CT2 AMENDMENTS	JOL	18/12/2023 VICTORIA LOUISE & STEPHEN MICHAEL VAN LOON	MONASH 11
WIL2011	COPYRIGHT:	3 (CT3 AMENDMENTS	JOL	15/01/2024 ADDRESS:	FACADE DESIGN:
	© 2024	4 I	PRELIM PLANS - INITIAL ISSUE	MT	19/02/2024 32 LIDDESDALE DRIVE, DELORAINE TAS 7304	CLASSIC
HUIIIES		5 I			2024.04.10 LOT / SECTION / CT: COUNCIL:	SHEET TITLE:
		6 I	PRELIM PLANS - RFI & VARIATION UPDATE	MLG	2024.06.07 19 / - / 185043 MEANDER VALLEY COUNCIL	SITE PLAN



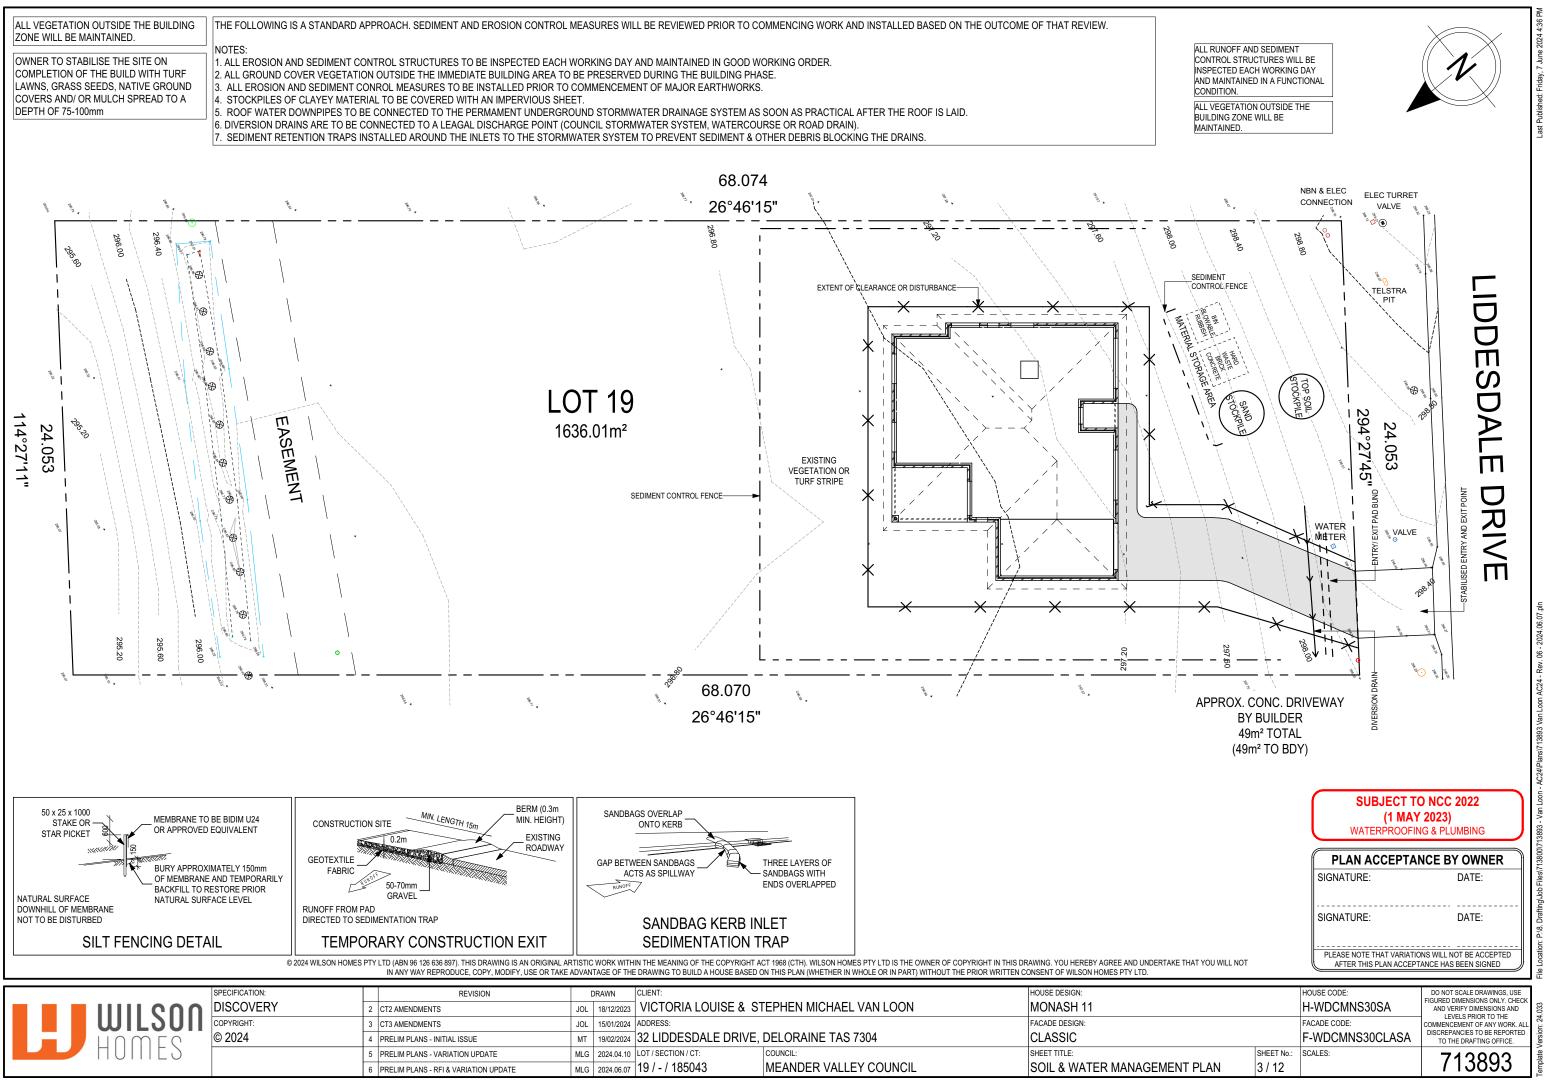

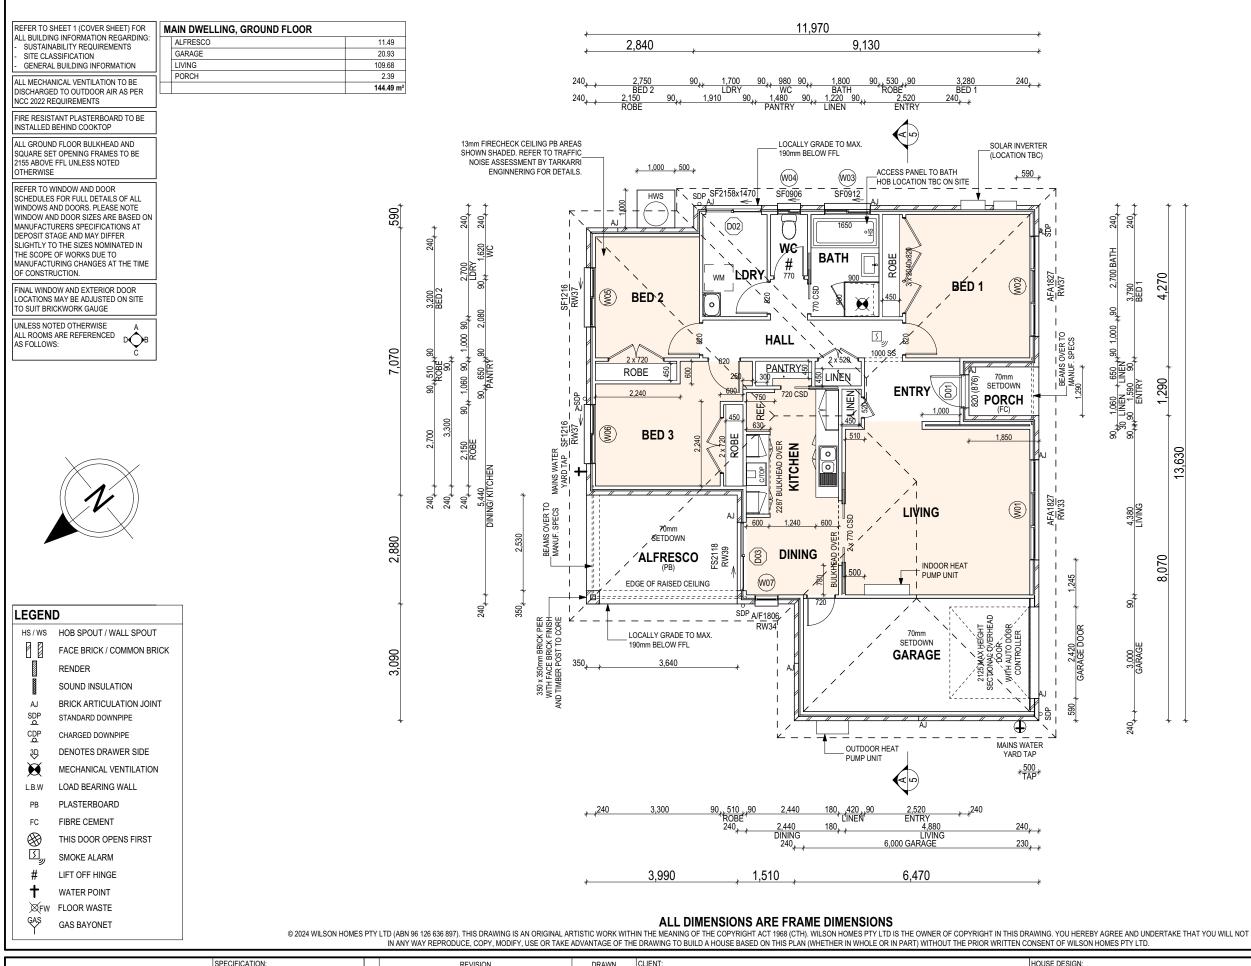	SPECIFICATION:	REVISION	D	RAWN	CLIENT:		HOUSE DESIGN:
	DISCOVERY	2 CT2 AMENDMENTS	JOL	18/12/2023	VICTORIA LOUISE & ST	EPHEN MICHAEL VAN LOON	MONASH 11
WILSUII	COPYRIGHT:	3 CT3 AMENDMENTS	JOL	15/01/2024	ADDRESS:		FACADE DESIGN:
IINMEC	© 2024	4 PRELIM PLANS - INITIAL ISSUE	MT	19/02/2024	32 LIDDESDALE DRIVE,	DELORAINE TAS 7304	CLASSIC
HUIIIE2		5 PRELIM PLANS - VARIATION UPDATE	MLG			COUNCIL:	SHEET TITLE:
		6 PRELIM PLANS - RFI & VARIATION UPDATE	MLG	2024.06.07	19 / - / 185043	MEANDER VALLEY COUNCIL	GROUND FLOOR PLAN

HAT FOU WILL NOT	AFTER THIS PLAN ACCEPT	ANCE HAS BEEN SIGNED
	HOUSE CODE: H-WDCMNS30SA FACADE CODE: F-WDCMNS30CLASA	DO NOT SCALE DRAWINGS, USE FIGURED DIMENSIONS ONLY. CHECK AND VERIFY DIMENSIONS AND LEVELS PRIOR TO THE COMMENCEMENT OF ANY WORK, ALL DISCREPANCIES TO BE REPORTED TO THE DRAFTING OFFICE.
SHEET No.: 4 / 12	scales: 1:100	713893

SIGNATURE:

SIGNATURE:

SUBJECT TO NCC 2022

(1 MAY 2023) WATERPROOFING & PLUMBING


PLAN ACCEPTANCE BY OWNER

PLEASE NOTE THAT VARIATIONS WILL NOT BE ACCEPTED

DATE:


DATE:

ALL EXTERIOR SLABS TO BE GRADED BY CONCRETER TO ACHIEVE APPROX. 1:100 FALL TO OUTSIDE EDGE WITH MAXIMUM CROSSFALL OF 30mm OVER ENTIRE SLAB.

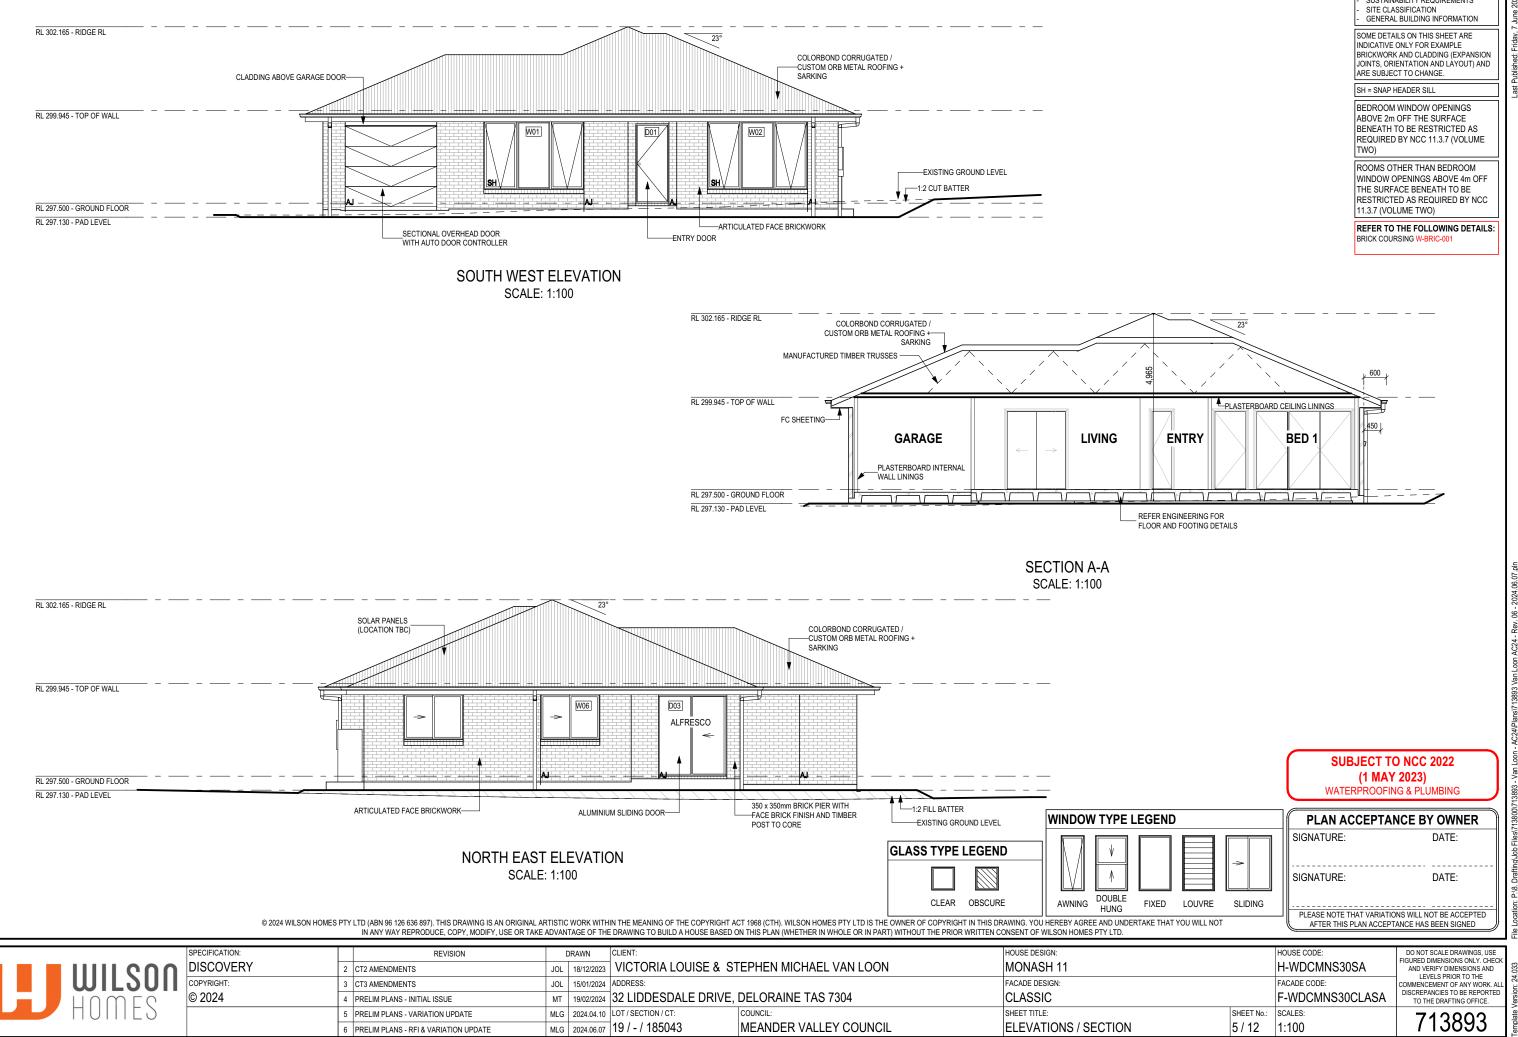


REFER TO SHEET 1 (COVER SHEET) FOR ALL BUILDING INFORMATION REGARDING:

SUSTAINABILITY REQUIREMENTS

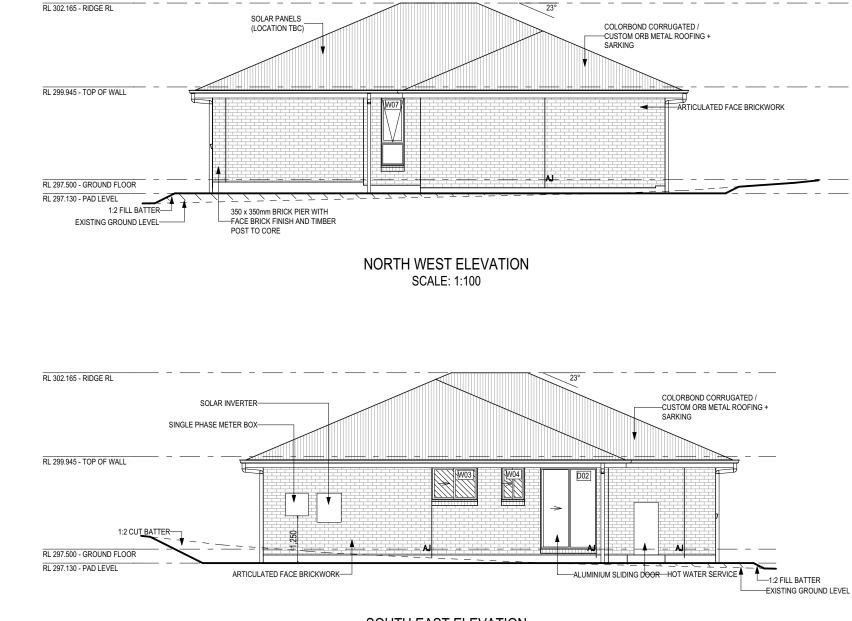

SOUTH EAST ELEVATION SCALE: 1:100

	WINDOW	TYPE	LEGE
٦			

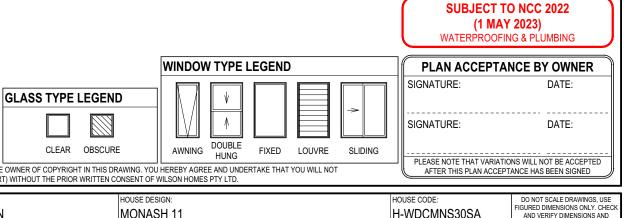

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	SPECIFICATION:	REVISION	DRAV	AWN CLI	ENT:		HOUSE DESIGN:
		CT2 AMENDMENTS	JOL 18/	^{B/12/2023} V	ICTORIA LOUISE & ST	EPHEN MICHAEL VAN LOON	MONASH 11
WIL30	COPYRIGHT: 3	CT3 AMENDMENTS	JOL 15/	5/01/2024 ADI	DRESS:		FACADE DESIGN:
	© 2024	PRELIM PLANS - INITIAL ISSUE	MT 19/	9/02/2024 32	2 LIDDESDALE DRIVE,	DELORAINE TAS 7304	CLASSIC
HUIIIE3	5					COUNCIL:	SHEET TITLE:
	6	PRELIM PLANS - RFI & VARIATION UPDATE	MLG 202	024.06.07 19	9 / - / 185043	MEANDER VALLEY COUNCIL	ELEVATIONS

ARE SUBJECT TO CHANGE. SH = SNAP HEADER SILL

BEDROOM WINDOW OPENINGS ABOVE 2m OFF THE SURFACE BENEATH TO BE RESTRICTED AS REQUIRED BY NCC 11.3.7 (VOLUME TWO)

ROOMS OTHER THAN BEDROOM WINDOW OPENINGS ABOVE 4m OFF THE SURFACE BENEATH TO BE RESTRICTED AS REQUIRED BY NCC 11.3.7 (VOLUME TWO)

REFER TO THE FOLLOWING DETAILS: BRICK COURSING W-BRIC-001

STOREY	ID	CODE ¹	TYPE	ROOM	HEIGHT	WIDTH	PERIMETER	AREA FRAME (m²) TYPE	SILL TYPE	ORIENT.	GLAZING AREA (m ²)	GLAZING TYPE (SINGLE GLAZING U.N.O.)	ADDITIONAL INFORMATION ²
VINDOW							I		1	1			L
GROUND FLOOR	W01	AFA1827	AWNING	LIVING	1,800	2,650	8,900	4.77 ALUMINIUM	SNAP HEADER	SW	3.93	CLEAR, DOUBLE GLAZED	MP 883-883, ACOUSTIC GLAZING 33RW R
GROUND FLOOR	W02	AFA1827	AWNING	BED 1	1,800	2,650	8,900	4.77 ALUMINIUM	SNAP HEADER	SW	3.93	CLEAR, DOUBLE GLAZED	MP 883-883, ACOUSTIC GLAZING 37RW R
GROUND FLOOR	W03	SF0912	SLIDING	BATH	860	1,210	4,140	1.04 ALUMINIUM	ANGLED	SE	0.86	OBSCURE, DOUBLE GLAZED	
GROUND FLOOR	W04	SF0906	SLIDING	WC	860	610	2,940	0.52 ALUMINIUM	ANGLED	SE	0.39	OBSCURE, DOUBLE GLAZED	
GROUND FLOOR	W05	SF1216	SLIDING	BED 2	1,200	1,570	5,540	1.88 ALUMINIUM	ANGLED	NE	1.64	CLEAR, DOUBLE GLAZED	ACOUSTIC GLAZING 37RW RATING
GROUND FLOOR	W06	SF1216	SLIDING	BED 3	1,200	1,570	5,540	1.88 ALUMINIUM	ANGLED	NE	1.64	CLEAR, DOUBLE GLAZED	ACOUSTIC GLAZING 37RW RATING
GROUND FLOOR	W07	A/F1806	AWNING	DINING	1,800	610	4,820	1.10 ALUMINIUM	ANGLED	NW	0.80	CLEAR, DOUBLE GLAZED	BP 600, ACOUSTIC GLAZING 34RW RATIN
								15.96			13.19		
OOR			·						•				
GROUND FLOOR	D01	820	SWINGING	ENTRY	2,097	876	5,946	1.84 ALUMINIUM	SNAP HEADER	SW	1.23	NVA	
GROUND FLOOR	D02	SF2158x1470	SLIDING	LDRY	2,158	1,470	7,256	3.17 ALUMINIUM	SNAP HEADER	SE	2.71	CLEAR, DOUBLE GLAZED, TOUGHENED	
GROUND FLOOR	D03	FS2118	SLIDING	DINING	2,158	1,810	7,936	3.91 ALUMINIUM	SNAP HEADER	NE	3.41	CLEAR, DOUBLE GLAZED, TOUGHENED	ACOUSTIC GLAZING 39RW RATING
								8.92			7.35		
								24.88			20.54		

STOREY	QTY	CODE	TYPE	HEIGHT	WIDTH GLAZING TYPE	ADDITIONAL I	NFORMATION				
OR											
GROUND FLOOR	1	1000 SS	SQUARE SET OPENING	2,155	1,000 N/A						
ROUND FLOOR	1	2 x 520	SWINGING	2,040	1,040 N/A						
ROUND FLOOR	2	2 x 720	SWINGING	2,040	1,440 N/A						
ROUND FLOOR	1	2 x 770 CSD	CAVITY SLIDING	2,040	1,540 N/A						
GROUND FLOOR	1	3 x 2040x820	SWINGING	2,040	2,494 N/A						
GROUND FLOOR	1	520	SWINGING	2,040	520 N/A						
GROUND FLOOR	1	720	SWINGING	2,040	720 N/A						
ROUND FLOOR	1	720 CSD	CAVITY SLIDING	2,040	720 N/A						
ROUND FLOOR	1	770	SWINGING	2,040	770 N/A	LIFT-OFF HINGE	S				
GROUND FLOOR	1	770 CSD	CAVITY SLIDING	2,040	770 N/A				F	PICTURE, TV RECESS ANI	D SS WINDOW OPENINGS
GROUND FLOOR	4	820	SWINGING	2,040	820 N/A					QTY TYPE	HEIGHT WIDTH AREA (m ²)
R TO SHEET 1 (CO					NOTE: INTERNAL DO	ORS TO WET AF	REAS WITH MEC	HANICAL VENTILATION TO BE UNDERCU	T 20mm		
UILDING INFORMA											
TE CLASSIFICATION ENERAL BUILDING I		TION	© 2024 WILSON HOME					IN THE MEANING OF THE COPYRIGHT ACT 1968 (CT E DRAWING TO BUILD A HOUSE BASED ON THIS PLA			
			SPECIFICATION:		REVISION		DRAWN	CLIENT:			HOUSE DESIGN:
	111		DISCOVERY	2 CT2	AMENDMENTS		JOL 18/12/2023	VICTORIA LOUISE & STEPHEN	I MICHAEL	VAN LOON	MONASH 11
	U	ILSON	COPYRIGHT:	3 CT3 /	AMENDMENTS		JOL 15/01/2024	ADDRESS:			FACADE DESIGN:
			© 2024	4 PREL	IM PLANS - INITIAL ISSUE		MT 19/02/2024	32 LIDDESDALE DRIVE, DELOR	AINE TAS 7	'304	CLASSIC
								ł r			
	Ηl	JIIIE9		5 PREL	IM PLANS - VARIATION UPDATE		MLG 2024.04.10	LOT / SECTION / CT: COUNCIL:			SHEET TITLE:

RATING
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Manufacturer - Clark Windows	7		
Window Type	Glazing	U-Value	SHGC
Awning	Single	6.5	0.67
	Double	4.1	0.57
Fixed	Single	5.9	0.75
	Double	3.2	0.67
Sliding	Single	6.4	0.76
	Double	4.2	0.59
Fixed Pane	Single	5.9	0.75
	Double	3.2	0.67
Fixed Glass Panel Hinged Door	Single	6.0	0.62
	Double	4.3	0.55
Sliding Door	Single	6.1	0.74
	Double	3.6	0.66
Stacking Door	Single	6.3	0.74
	Double	3.8	0.66
135 deg. Awning Bay Window	Single	6.5	0.67
	Double	4.1	0.57
135 deg. Sliding Bay Window	Single	6.5	0.76
	Double	4.2	0.59
90 deg. Awning Bay Window	Single	6.5	0.67
	Double	4.1	0.57
90 deg. Sliding Bay Window	Single	6.5	0.76
	Double	4.2	0.59
Bifold Doors	Single	6.1	0.61
	Double	4.4	0.53
NOTE:			

NOTE: Windows supplied MUST HAVE Uw better and or equal to stated figures and SHGC within +/- 5% of stated figures. Restricted windows to have their openability restricted as per N.C.C 11.3.6.



PLAN ACCEPTANCE BY OWNER DATE:

SIGNATURE:

SIGNATURE:

----DATE:

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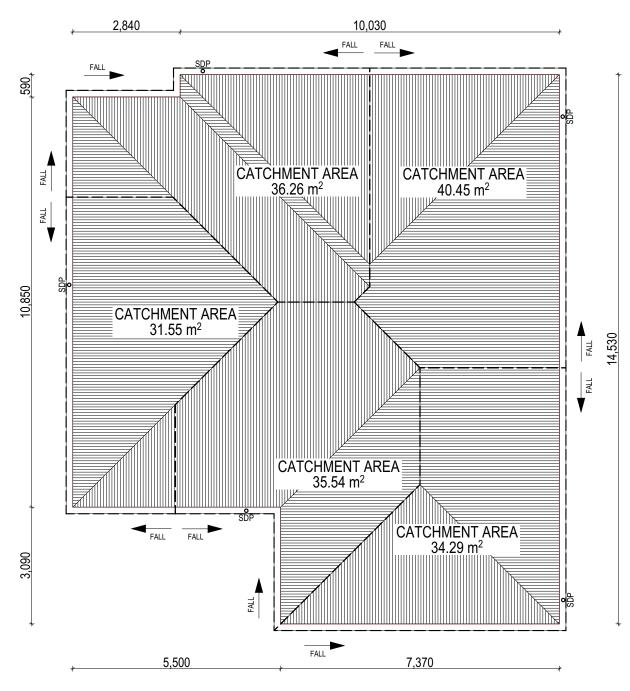
PLEASE NOTE THAT VARIATIONS WILL NOT BE ACCEPTED AFTER THIS PLAN ACCEPTANCE HAS BEEN SIGNED

				. –
HOUSE DESIGN: MONASH 11		HOUSE CODE: H-WDCMNS30SA	DO NOT SCALE DRAWINGS, USE FIGURED DIMENSIONS ONLY. CHECK AND VERIFY DIMENSIONS AND	.033
FACADE DESIGN: CLASSIC		FACADE CODE: F-WDCMNS30CLASA	LEVELS PRIOR TO THE COMMENCEMENT OF ANY WORK. ALL DISCREPANCIES TO BE REPORTED TO THE DRAFTING OFFICE.	/ersion: 24
SHEET TITLE: WINDOW & DOOR SCHEDULES	SHEET No.: 7 / 12	SCALES:	713893	Template \

WHERE DOWNPIPES ARE FURTHER THAN 1.2m AWAY FROM VALLEY REFER TO N.C.C. 7.3.5(2)
POSITION AND QUALITY OF DOWNPIPES ARE NOT TO BE ALTERED WITHOUT

CONSULTATION WITH DESIGNER. AREA'S SHOWN ARE SURFACE AREAS CATCHMENT AREAS, NOT PLAN AREAS

Roofi	ng Data	
	168.33	Flat Roof Area (excluding gutter and slope factor) (m ²)
	182.86	Roof Surface Area (includes slope factor, excludes gutter) (m ²)
Dowr	pipe roof	calculations (as per AS/NZA3500.3:2018)
Ah	178.09	Area of roof catchment (including 115mm Slotted Quad Gutter) (m ²)
Ac	215.48	Ah x Catchment Area Multiplier for slope (Table 3.4.3.2 from AS/NZS 3500.3:2018) (1.21 for 23 [°] pitch) (m ²)
Ae	6300	Cross sectional area of 57 x 115 Slotted Quad Gutter (mm ²)
DRI	108	Design Rainfall Intensity (determined from Table E1 from AS/NZS 3500.3:2018)
Acdp	64	Catchment area per Downpipe (determined from Figure 3.5(A) from AS/NZS 3500.3:2018) (m ²)
Required Downpipes	3.36	Ac / Acdp
Downpipes Provided	5	



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	SPECIFICATION:		REVISION	DRAWN	C	CLIENT:		HOUSE DESIGN:
	DISCOVERY	2	CT2 AMENDMENTS	JOL 18/12/20	023	VICTORIA LOUISE & ST	EPHEN MICHAEL VAN LOON	MONASH 11
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	© 2024	4	PRELIM PLANS - INITIAL ISSUE	MT 19/02/20	024 3	32 LIDDESDALE DRIVE, I	DELORAINE TAS 7304	CLASSIC
HUIIIES		5	PRELIM PLANS - VARIATION UPDATE	MLG 2024.04	4.10 L	.OT / SECTION / CT:	COUNCIL:	SHEET TITLE:
		6	PRELIM PLANS - RFI & VARIATION UPDATE	MLG 2024.06	6.07	19 / - / 185043	MEANDER VALLEY COUNCIL	ROOF DRAINAGE PLAN

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EV SOFFIT EAVE VENT PROPOSED LOCATION TO BE MIN. 1M FROM CORNER JOINT SUBJECT TO NCC 2022 (1 MAY 2023) WATERPROOFING & PLUMBING PLAN ACCEPTANCE BY OWNER SIGNATURE: DATE: SIGNATURE: DATE: PLEASE NOTE THAT VARIATIONS WILL NOT BE ACCEPTED AFTER THIS PLAN ACCEPTANCE HAS BEEN SIGNED DO NOT SCALE DRAWINGS, USE FIGURED DIMENSIONS ONLY, CHECK AND VERIFY DIMENSIONS AND LEVELS PRIOR TO THE COMMENCEMENT OF ANY WORK ALL DISCREPANCIES TO BE REPORTED TO THE DRAFTING OFFICE. HOUSE CODE: H-WDCMNS30SA FACADE CODE: F-WDCMNS30CLASA SHEET No.: SCALES: 713893


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AL	L BUILDING INFORMATION REGARDING
-	SUSTAINABILITY REQUIREMENTS
-	SITE CLASSIFICATION
-	GENERAL BUILDING INFORMATION
_	

FLOOR TILES SHOWN ON PLAN DO NOT INDICATE THE SIZE OR JOINT LOCATIONS OF THE ACTUAL FLOOR TILES. TIMBER FLOORING SHOWN ON PLAN DOES NOT INDICATE THE BOARD SIZE OR DIRECTION OF THE ACTUAL FLOORING.

COVERINGS LEGEND


NO COVERING COVER GRADE CONCRETE CARPET LAMINATE TILE (STANDARD WET AREAS) TILE (UPGRADED AREAS) DECKING

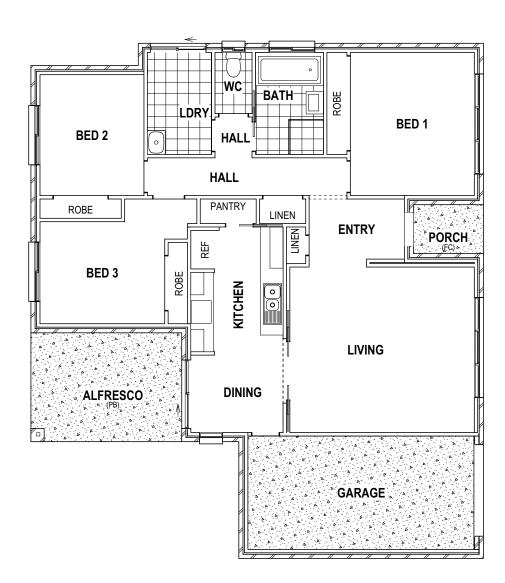

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		DISCOVERY	2 CT2 AMENDMENTS	JOL 18/12/2023	VICTORIA LOUISE & ST	TEPHEN MICHAEL VAN LOON	MONASH 11
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	HOMES	© 2024	4 PRELIM PLANS - INITIAL ISSUE	MT 19/02/2024	32 LIDDESDALE DRIVE,	DELORAINE TAS 7304	CLASSIC
					LOT / SECTION / CT:	COUNCIL:	SHEET TITLE:
			6 PRELIM PLANS - RFI & VARIATION UPDATE	MLG 2024.06.07	19 / - / 185043	MEANDER VALLEY COUNCIL	FLOOR COVERINGS

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6 PRELIM PLANS - RFI & VARIATION UPDATE

MLG 2024.06.07 19 / - / 185043

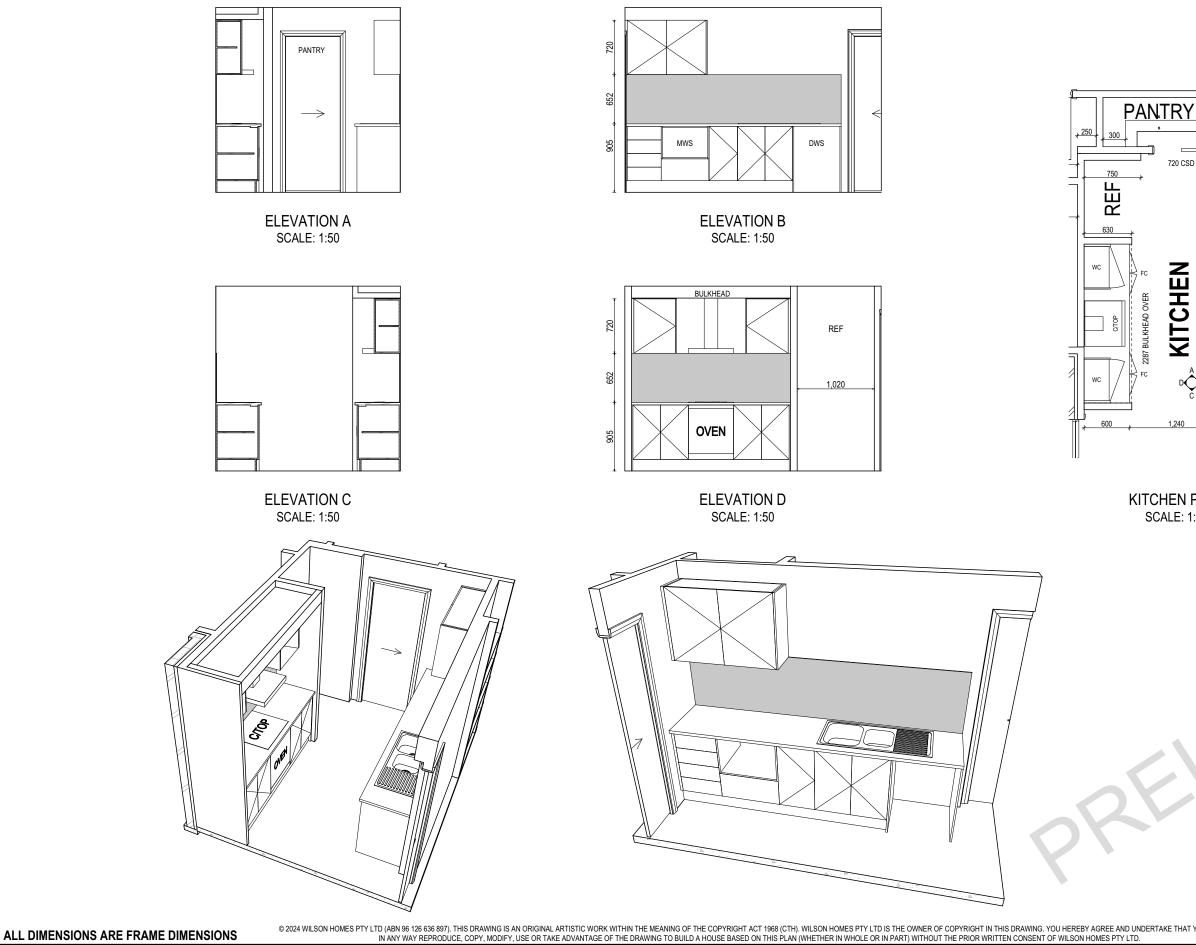MEANDER VALLEY COUNCIL


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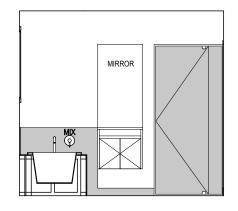
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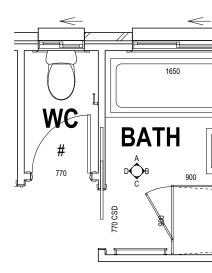
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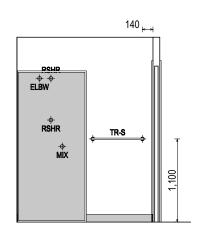
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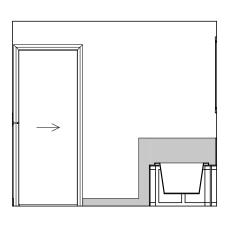
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BATHROOM PLAN SCALE: 1:50



ELEVATION C SCALE: 1:50




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		SPECIFICATION:		REVISION		DRAWN CLIENT:		HOUSE DESIGN:
		DISCOVERY	2	CT2 AMENDMENTS	JOL	18/12/2023 VICTORIA LOUISE & S	TEPHEN MICHAEL VAN LOON	MONASH 11
	WIL3011	COPYRIGHT:	3	CT3 AMENDMENTS	JOL	15/01/2024 ADDRESS:		FACADE DESIGN:
		© 2024	4	PRELIM PLANS - INITIAL ISSUE	MT	19/02/2024 32 LIDDESDALE DRIVE,	DELORAINE TAS 7304	CLASSIC
	HUIIE3		5			2024.04.10 LOT / SECTION / CT:	COUNCIL:	SHEET TITLE:
			6	PRELIM PLANS - RFI & VARIATION UPDATE	MLG	2024.06.07 19 / - / 185043	MEANDER VALLEY COUNCIL	BATHROOM DETAILS
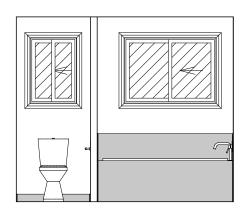
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	VANITY DETAI WINDOW OVE STANDARD BA	HE FOLLOWII LS G-VANI-001 R BATH HOB D- ATH HOB D-WET ING LAYOUTS I	-WIN FA-B	D-ALU001 ATH003	ALL BUI - SUS - SITE	LDING I TAINABI CLASSI	NFORMATI LITY REQU FICATION	ER SHEET) FOR ON REGARDING: IIREMENTS FORMATION	Last Published: Friday, 7 June 2024 4:36 PN
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		DISCOVERY	2 CT2 AMENDMENTS	JOL 18/12/2023	VICTORIA LOUISE & STEPHEN MICHAEL VAN LOON	MONASH 11
	WILSUII	COPYRIGHT:	3 CT3 AMENDMENTS	JOL 15/01/2024	ADDRESS:	FACADE DESIGN:
		© 2024	4 PRELIM PLANS - INITIAL ISSUE	MT 19/02/2024	32 LIDDESDALE DRIVE, DELORAINE TAS 7304	CLASSIC
	HUIIIES				LOT / SECTION / CT: COUNCIL:	SHEET TITLE:
			6 PRELIM PLANS - RFI & VARIATION UPDATE	MLG 2024.06.07	19 / - / 185043 MEANDER VALLEY COUNCIL	LAUNDRY DETAILS

		ALL BUILDIN - SUSTAIN - SITE CLA - GENERAI DETAILS DE	HEET 1 (COVER SHEET) FOR G INFORMATION REGARDING: ABILITY REQUIREMENTS SSIFICATION L BUILDING INFORMATION PICTED ON THIS SHEET ARE A TATION ONLY
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JNDRY DETAILS	12 / 12	1:50	110030

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Technical Memo

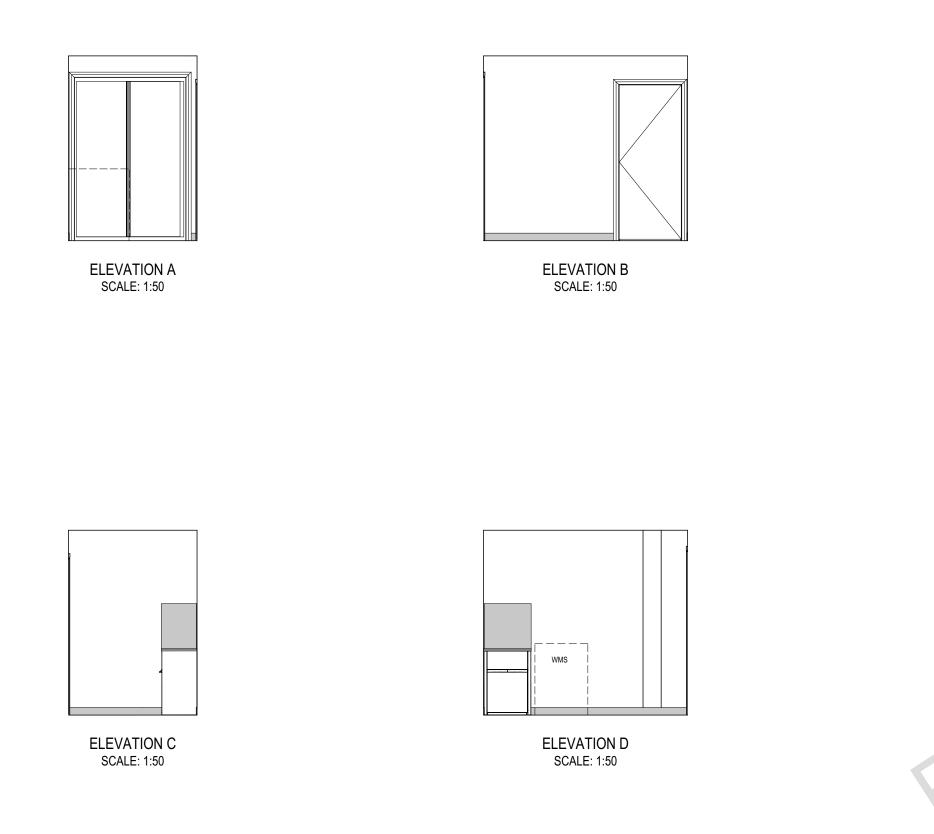21 June 2024

Wilson Homes 250 Murray St Hobart, TAS 7000

5922_AC_R_R1 AJM

Attn: Mr Mark Page

Dear Sir,

RE: Lot 19, 32 Liddesdale Dr, Deloraine, traffic noise assessment.

Please find below our report on a traffic noise assessment a proposed dwelling at Lot 19, 32 Liddesdale Dr, Deloraine.

1. INTRODUCTION

Tarkarri Engineering was commissioned by Wilson Homes to conduct traffic noise assessment for a proposed single-storey dwelling at Lot 19, 32 Liddesdale Dr, Deloraine. The assessment addresses Performance C3.0 Road and Railway Assets Code of the *Tasmanian Planning Scheme – State Planning Provisions* with regard habitable buildings for sensitive uses within a road or railway attenuation area.

A road traffic noise assessment for the residential subdivision of Liddesdale Dr, Deloraine (with Lot 19, 32 Liddesdale Dr near to this) was conducted in 2023 (see Tarkarri Engineering report 5821_AC_R for details). From this report projected traffic noise levels were provided for lots that bound the Bass Hwy at given set back distances from the road easement. The relevant projected traffic noise level for the proposed dwelling on Lot 19, 32 Liddesdale Dr is 68 L_{A10,18hr}.

Under the subdivision assessment where the desired traffic noise limit criterion of 63 dBA L_{A10,18hr} is exceeded at a proposed dwelling facade then an assessment of the proposed dwelling is required in accordance with section 5.3 *Internal traffic daytime noise criterion* of the *Tasmanian State Road Traffic Noise Management Guidelines*, provided below for reference.

5.3 Internal traffic daytime noise criterion

Internal traffic noise means traffic noise measured inside a building.

Internal traffic noise may need to be considered in circumstances where it is not be possible to achieve external noise targets.

The Department may then consider acoustical treatment of sensitive use buildings to reduce traffic noise intrusion into the building.

The Tasmanian Environment Protection Policy (Noise) 2009 establishes a daytime indoors indicator level of $L_{Aeq}(16 \text{ hour})$ 35 dB(A).

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The nominal internal design criterion for this approach will therefore be $L_{\text{Aeq}}(16 \text{ hour})$ 35 dB(A).

However, because of the many differences between building designs and construction and how people use internal spaces, the Department will not use this nominal design criterion as the target for internal noise. Instead, the Department will first use the measured or predicted external noise $L_{A10}(18 \text{ hour})$ to calculate an assumed internal $L_{Aeq}(16 \text{ hour})$ using the relationship:

 $L_{Aeq}(16 \text{ hour}) = L_{A10}(18 \text{ hour}) - 2.0 \text{ dB}(A).$

The Department will then use AS3671-1989 Acoustics – Road traffic noise intrusion – building siting and construction to determine acoustical treatments that could best mitigate the external L_{Aeq}(16 hour) noise to achieve the nominal design criterion for internal noise of L_{Aeq}(16 hour) 35 dB(A)

2. SITE DESCRIPTION

Lot 19, 32 Liddesdale Dr Street bounds the Bass Hwy road corridor to the north. The new dwelling proposed would be located approx. 44 m from the boundary with the road corridor.

Figure 2-1 presents a site plan for Lot 19, 32 Liddesdale Dr while Figures 2-2 to 2-4 present floor plans and elevations for the proposed dwelling.

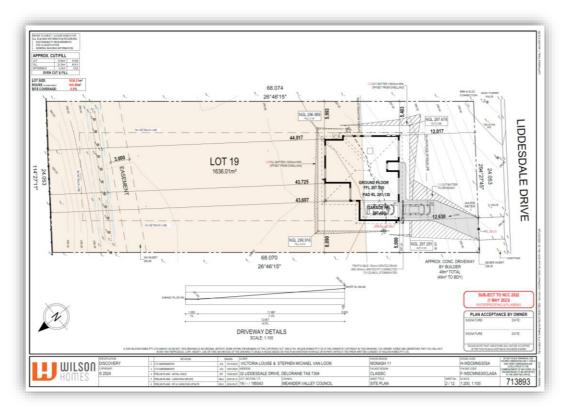
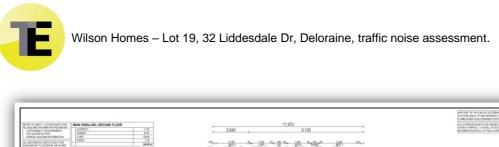


Figure 2-1: Site plan of proposed dwelling (provided by Wilson Homes).



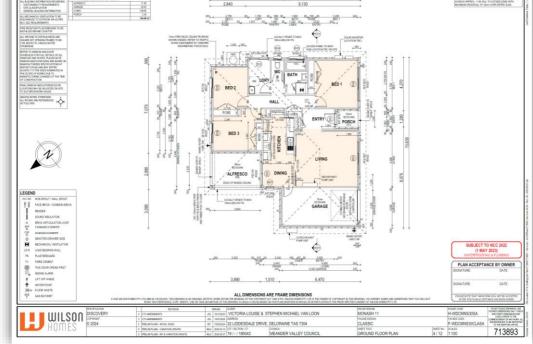
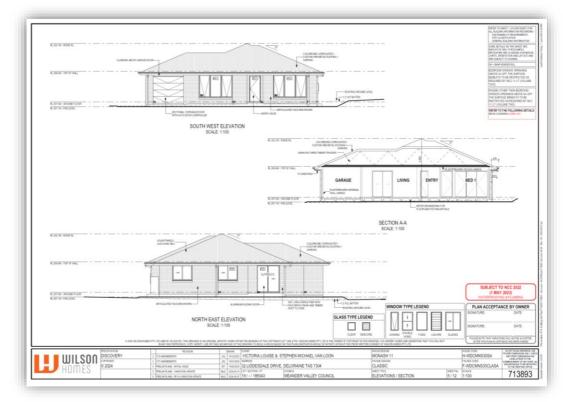


Figure 2-2: Floor plan of proposed dwelling (provided by Wilson Homes).





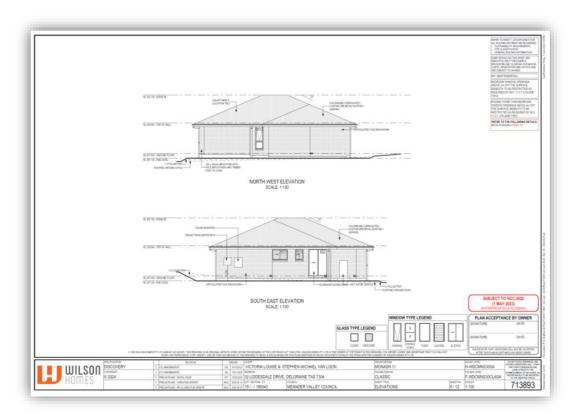


Figure 2-3: Elevations of proposed dwelling (provided by Wilson Homes).

3. FACADE ASSESSMENT

Following the procedures under *AS3671-1989*, as required under the *TSRTNMG*, weighted sound reduction index values (Rw) were calculated for the facade elements of each sensitive space within the proposed dwelling to allow a reduction of 31 dB across the facade. Table 4-1 presents the Rw requirements along with comments regarding required facade upgrades for the proposed design to meet the requirements.

Facade element Rw requirements								
Room	Element	Comments						
Master Bedroom	Roof/ceiling	44	Upgraded ceiling plasterboard					
	Wall	42	Proposed construction sufficient					
	Window	37	Upgraded double glazing required					
Bedroom 2	Roof/ceiling	44	Upgraded ceiling plasterboard					
	Walls	43	Proposed construction sufficient					
	Window	37	Upgraded double glazing required					
Bedroom 3	Roof/ceiling	44	Upgraded ceiling plasterboard					
	Walls	43	Proposed construction sufficient					
	Window	37	Upgraded double glazing required					
Living	Roof/ceiling	43	Upgraded ceiling plasterboard					
	Walls	37	Proposed construction sufficient					
	Window	33	Upgraded double glazing required					



Wilson Homes – Lot 19, 32 Liddesdale Dr, Deloraine, traffic noise assessment.

Kitchen/Dining	Roof/ceiling	45	Upgraded ceiling plasterboard
	Walls	38	Proposed construction sufficient
	Windows	34	Upgraded double glazing required
	Doors	39	Upgraded sliding door system required

Table 4-1: Facade Rw requirements.

NB: A derating of 3 is allowed for Rw performance requirements for elements in the southern facade (i.e. southern facade windows in Master Bedroom and Living) is allowed with this facade not directly impacted by traffic noise from the Hwy.

Further to the comments above the following adjustments to the design have been made in accordance with the traffic noise assessment and are detailed in the DA drawing set:

- The ceiling plasterboard upgraded to 13 mm Fyrchek, surface mass of 10.5 kg/m², or equivalent.
- Upgrade window double glazed unit in Master Bedroom to provide minimum Rw 37 acoustic performance.
- Upgrade window double glazed units in Bedroom 2, Bedroom 3 and Bedroom 4 to provide minimum Rw 37 acoustic performance.
- Upgrade window double glazed unit in the Living area to provide minimum Rw 33 acoustic performance.
- Upgrade window double glazed unit in the Kitchen / Dining area to provide minimum Rw 34 acoustic performance and the double glazed sliding door system to provide minimum Rw 39 acoustic performance.

I hope this information meets your immediate requirements.

Please contact me directly if you have any questions concerning this work.

Yours faithfully, Tarkarri Engineering Pty Ltd

Alox Mc Level

Dr. Alex M^cLeod Principal Consultant

m. +61(0)439 357 297 email: <u>alex.mcleod@tarkarri.com</u>



Proposed Residenital Development 32 Liddesdale Drive, Deloraine

Bushfire Hazard Report

Applicant: Wilson Homes Job Number: 713893



October 2023 J9591v1

Geo Environmental Solutions 29 Kirksway Place, Battery Point, Tasmania. T| 62231839 E| office@geosolutions.net.au W| www.geosolutions.net.au

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Attachment 1 - Certificate of Others (form 55)

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1.0 Purpose

This bushfire hazard report is intended to demonstrate how the proposal complies with the relevant regulatory framework. It will demonstrate compliance with the *Building Regulations 2016*, and the *Directors Determination – Bushfire Hazard Areas, version 1.1, 12th April 2021*. Provide a certificate of others (form 55) as specified by the Director of Building Control.

2.0 Summary

Title reference	185043/19
PID	9376301
Address	32 Liddesdale Drive, Deloraine
Applicant	Wilson Homes
Municipality	Meander
Planning Scheme	Tasmanian Planning Scheme - Meander
Zoning	Low Density Residential
Bushfire Attack Level	BAL-LOW

Development of a new class 1a building at 32 Liddesdale Drive, Deloraine, requires demonstrated compliance with *Building Regulations 2016*. The Bushfire attack level has been determined as 'BAL-LOW' for the site, there are no specific requirements for the provision of property access, water supplies for firefighting or for hazard management areas for this proposal.

3.0 Introduction

This bushfire attack level assessment has been completed to form part of supporting documentation for a building permit application for the proposed development. The proposed development site has been identified as potentially being in a bushfire prone area.

4.0 Proposal

It is proposed that a new class 1a building is developed at 32 Liddesdale Drive, Deloraine (appendix A).

5.0 Bushfire Attack Level (BAL) Assessment

5.1 Methods

The Bushfire attack level has been determined through the application of section 2 of AS3959-2018 'Simplified Procedure'. Vegetation has been classified using a combination of onsite observations and remotely sensed data to be consistent with table 2.3 of AS359-2018. Slope and distances have been determined by infield measurement and/or the use of remotely sensed data (aerial/satellite photography, GIS layers from various sources) analysed with proprietary software systems. Where appropriate vegetation has been classified as low threat.

5.2 Site Description

The proposal is located at 32 Liddesdale Drive, Deloraine, in the municipality of Meander and is zoned Low Density Residential under the Tasmanian Planning Scheme – Meander. Access to the lot will be by an existing crossover from Liddesdale Drive, a council-maintained road. The lot is ~0.161 Ha, is rectangular in shape and is located approximately 5.5km south-east of Brumbys Folly (Figure 1). Adjacent are zoned Low Density Residential, Infrastructure and Agriculture. At a landscape scale the lot occurs within a new subdivision on the northern extent of the Deloraine settled area. Vegetation cover in the surrounding area is dominated grasslands. The lot is effectively flat with no definitive aspect.



Figure 1. Location of the lot in a topographical context, lot outlined in pink.

Azimuth	Vegetation Classification	Effective Slope	Distance to Bushfire- prone vegetation	Bushfire Attack Level	
	Exclusion 2.2.3.2 (e, f) ^A	flat 0°	0 to 85 metres		
	Grassland [^]	flat 0°	85 to 100 metres		
North-east				BAL-LOW	
_					
	Exclusion 2.2.3.2 (e, f) ^A	flat 0°	0 to 100 metres		
South-east				BAL-LOW	
			-		
	Exclusion 2.2.3.2 (e, f) [^]	flat 0°	0 to 100 metres		
				BAL-LOW	
South-west	-				
	Exclusion 2.2.3.2 (e, f) ^A	flat 0°	0 to >100 metres		
North-west				BAL-LOW	

Vegetation classification as per AS3959-2018 and Figures 2.4 (A) to 2.4 (H).
 Low threat vegetation as per Bushfire Prone Areas Advisory Note (BHAN) No.1-2014, version 3, 8/11/2017.
 Exclusions as per AS3959-2018, section 2.2.3.2, (a) to (f).



Figure 2. Shows the lot in the context of surrounding lands and vegetation.

6.0 Results

The bushfire attack level for the site has been determined as **BAL-LOW**. There is an insufficient increase in the risk from bushfire to the site to warrant specific bushfire protection measures in this circumstance.

7.0 Compliance

The Bushfire Attack Level has been determined as BAL-LOW. AS3959-2018 does not provide construction requirements for buildings assessed in bushfire-prone areas in accordance with section 2 as being BAL-LOW. There are no design or construction requirements relating to; property access, water supplies for firefighting or hazard management areas in this circumstance. In accordance with s3, (1), (i) of the Director's Determination – Bushfire Hazard Areas, a certificate (form 55) is provided that states that a Bushfire Hazard Management Plan is not required in this circumstance.

8.0 Limitations Statement

This Bushfire Hazard Report has been prepared in accordance with the scope of services between Geo-Environmental Solutions Pty. Ltd. (GES) and the applicant named in section 2. To the best of GES's knowledge, the information presented herein represents the Client's requirements at the time of printing of the Report. However, the passage of time, manifestation of latent conditions or impacts of future events may result in findings differing from that described in this Report. In preparing this Report, GES has relied upon data, surveys, analyses, designs, plans and other information provided by the Client and other individuals and organisations referenced herein. Except as otherwise stated in this Report, GES has not verified the accuracy or completeness of such data, surveys, analyses, designs, plans and other information.

The scope of this study does not allow for the review of every possible bushfire hazard condition and does not provide a guarantee that no loss of property or life will occur as a result of bushfire. As stated in AS3959-2018 "It should be borne in mind that the measures contained in this Standard cannot guarantee that a building will survive a bushfire event on every occasion. This is substantially due to the degree of vegetation management, the unpredictable nature and behaviour of fire, and extreme weather conditions". In addition, no responsibility is taken for any loss which is a result of actions contrary to AS3959-2018 or the Tasmanian Planning Commission Bushfire code.

This report does not purport to provide legal advice. Readers of the report should engage professional legal practitioners for this purpose as required. No responsibility is accepted for use of any part of this report in any other context or for any other purpose by third party.

9.0 References

Directors Determination – Bushfire Hazard Areas, version 1.1, 12th April 2021

Australian Standard 3959-2018 Construction of Buildings in Bushfire-prone Areas'. Standards Australia, Sydney.

Building Regulations 2016, (Tas.), div. 6 – Bushfire-prone Areas. (Austl.)


Building Regulations 2014, (Tas.) part 1A – Bushfire-prone Areas. (Austl.)

Tasmanian Planning Scheme - Meander, Tasmanian Planning Commission.


Bushfire-prone Areas Advisory Note No. 01-2014. v3.0. 8th November 2017. *Assessment of vegetation within suburban areas*. Tasmania Fire Service, Hobart.

Bushfire-prone Areas Advisory Note No. 04-2016. V3.0. 29th August 2017. *Chief Officer's Approved Form for a Bushfire Hazard Management Plan*. Tasmania Fire Service, Hobart

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Appendix A – Site Plan
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Bushfire Hazard Report - 32 Liddesdale Drive, Deloraine, March 2023, J9591v1.0

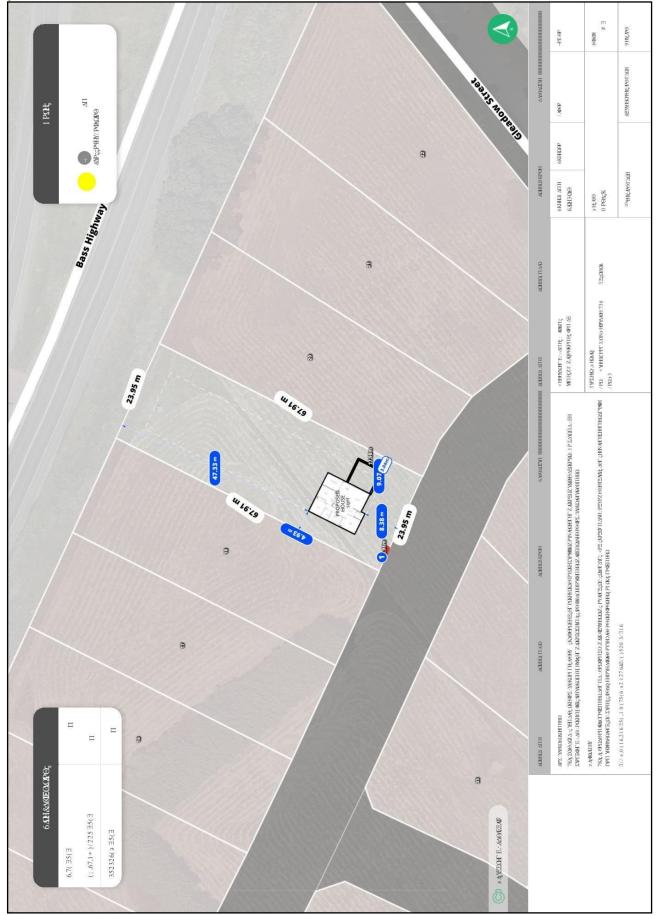

Site Calculations	
SITE AREA	1,627.87m ²
EXISTING FLOOR AREA	0.00m ²
PROPOSED AREA	114.51m ²

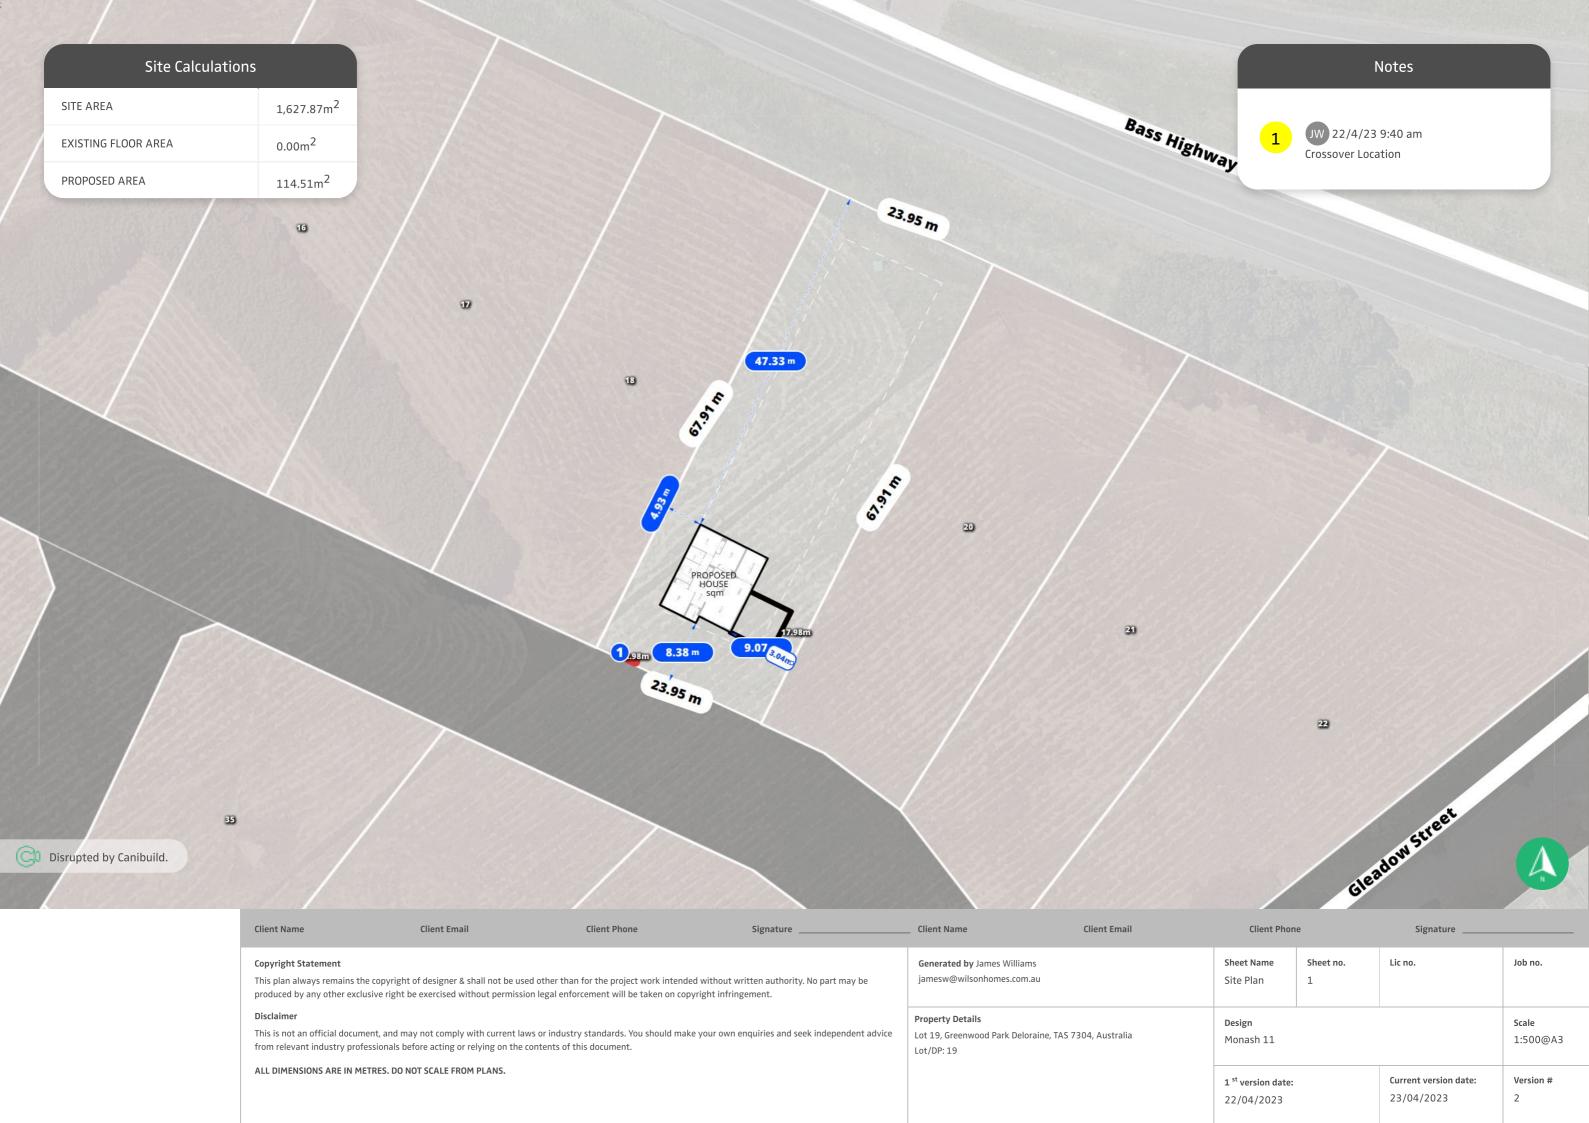

£1.0.13

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Client Name

Client Email

Client Phone

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Signature _____

_ Client Name

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Client Email

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Property Details

Generated by James Williams jamesw@wilsonhomes.com.au

Lot 19, Greenwood Park Deloraine, TAS 7304, Australia Lot/DP: 19


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Client Phone		e	Signature		
	Sheet Name Site Plan	Sheet no. 2	Lic no.	Job no.	
	Design Monash 11			Scale 1:200 @A3	
	1 st version date: 22/04/2023		Current version date: 23/04/2023	Version # 2	

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Client Phon	e	Signature	
Sheet Name Site Plan	Sheet no. 3	Lic no.	Job no.
Design Monash 11			Scale 1:100@A3
1 st version date: 22/04/2023		Current version date: 23/04/2023	Version # 2

CERTIFICATE OF QUALIFIED PERSON – ASSESSABLE ITEM

Section 321

To:	Wilson Homes		Owner /Agent	E E	
	250 Marray Street		Address	Form 55	
	Hobart TAS 7000		Suburb/postcode		
Qualified perso	on details:				
Qualified person:	Mark Van den Berg				
Address:	29 Kirksway Place			Phone No:	03 6223 1839
	Battery Point TAS	7	004	Fax No:	
Licence No:	FP-108 Email address: m	vand	enberg	@geosolutio	ns.net.au
Qualifications and Insurance details:	Accredited to report on bushfir hazards under Part IVA of the Service Act. BFP-108 scope 1, 2, 3a, 3b, 3 Sterling Insurance PI policy No 17080170	Fire c.	Directo	ption from Column : r's Determination - lified Persons for A	Certificates
Speciality area of expertise:	Analysis of bushfire hazards in bushfire prone areas(description from Column 4 of the Director's Determination - Certificates by Qualified Persons for Assessable Items)				
Details of work	1				
Address:	32 Liddesdale Drive				Lot No: 18
	Deloraine	7	304	Certificate of t	title No: 185043
The assessable item related to this certificate:	New building work in a bushfire prone area.		one	 (description of the assessable item being certified) Assessable item includes – a material; a design a form of construction a document testing of a component, building system or plumbing system an inspection, or assessment, performed 	
Certificate details:					
Certificate type:	Schedule Determin		on from Column 1 c 1 of the Director's ation - Certificates b Persons for Assess	by	
This certificate is ir	n relation to the above assessable item building work, plumbing wo			•	
	or				

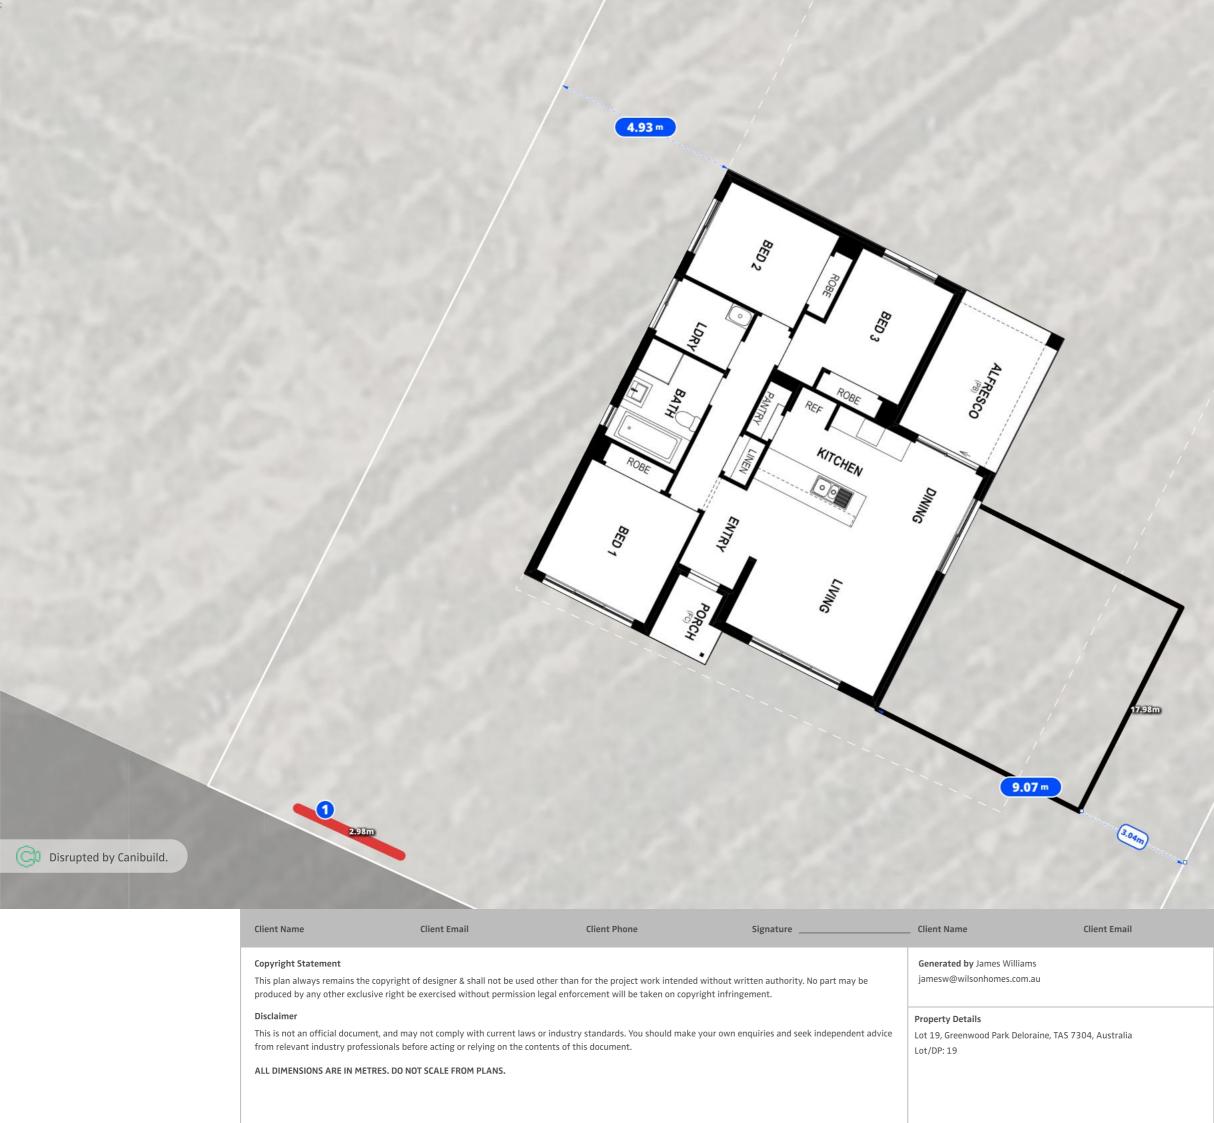a building, temporary structure or plumbing installation:

In issuing this certificate the following matters are relevant –

Documents:	Bushfire Hazard Report 32 Liddesdale Drive, Deloraine. October 2023 J9591v1. and Form 55
Relevant calculations:	Not Applicable.
References:	Directors Determination – Bushfire Hazard Areas, version 1.1, 12 th April 2021. Consumer, Building and Occupational Services, Department of Justice, Tasmania. Building Amendment (Bushfire-Prone Areas) Regulations 2014 Standards Australia 2018, Construction of buildings in bushfire prone areas, Standards Australia, Sydney

Substance of Certificate: (what it is that is being certified)

The Bushfire Attack Level has been determined to be BAL-LOW. There is an insufficient increase in risk to the dwelling and occupants from bushfire to warrant specific bushfire protection measures in this circumstance. There is no requirement for the provision of hazard management areas or water supplies for firefighting and there are no specific design or construction standards for property access for the proposed class 1a development.

I also certify that there is no requirement for a Bushfire Hazard Management Plan in this circumstance.

Scope and/or Limitations

Scope: This report was commissioned to identify the Bushfire Attack Level for the existing property. Limitations: The inspection has been undertaken and report provided on the understanding that;-1. The report only deals with the potential bushfire risk all other statutory assessments are outside the scope of this report. 2. The report only identifies the size, volume and status of vegetation at the time the site inspection was undertaken and cannot be relied upon for any future development. 3. Impacts of future development and vegetation growth have not been considered.

I certify the matters described in this certificate.

Qualified person:

Madas

Sianed:

Certificate No: J9591

Date: 23/10/2023